Newton Center for Active Living

CIVIL

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architect bha

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PROJECT NAME

Newton Center for Active Living 345 Walnut Street, Newton, MA. 02460

CLIENT

City of Newton

PROJECT T

CIVIL ENGINEER
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REVISIONS

DRAWING TITLE

Cover Sheet

RAWING INFORMATION

June 28, 2022

DATE OF ISSUE

Site Plan Approval

Site Plan Approval
DESCRIPTION

A
SCALE

DRAWING N

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BH+A, Inc.

REFERENCE

- 1. PROJECT LOCATION: NEWTON CENTER FOR ACTIVE LIVING, 345 WALNUT STREET, NEWTON, MASSACHUSETTS 02460. ASSESSOR'S MAP 24, LOT 1.
- 2. EXISTING CONDITIONS MAPPING TAKEN FROM PLAN ENTITLED "BOUNDARY, TOPOGRAPHIC, & UTILITY SURVEY" PREPARED BY CONTROL POINT ASSOCIATES, INC., DATED SEPTEMBER 25, 2020

GENERAL NOTES

AND OWNER'S REPRESENTATIVE AS REQUIRED.

- 1. THE COMMONWEALTH OF MASSACHUSETTS STANDARD SPECIFICATIONS FOR HIGHWAYS AND BRIDGE CONSTRUCTION, 2021 EDITION OR LATEST REVISION, AND THE MASSACHUSETTS DEPARTMENT OF TRANSPORTATION CONSTRUCTION STANDARD DETAILS ARE MADE A PART HEREOF AS FULLY AND COMPLETELY AS IF ATTACHED HERETO. ALL WORK SHALL MEET OR EXCEED THE MASSACHUSETTS STANDARD SPECIFICATIONS FOR HIGHWAY AND BRIDGE CONSTRUCTION, WITH LATEST REVISIONS. THE LATEST REVISION OF THE STANDARD SPECIFICATIONS MAY BE OBTAINED AT THE MASSACHUSETTS DEPARTMENT OF TRANSPORTATION.
- 2. THE CONTRACTOR SHALL MAKE ALL NECESSARY CONSTRUCTION NOTIFICATIONS AND APPLY FOR AND OBTAIN ALL NECESSARY CONSTRUCTION PERMITS, PAY ALL FEES AND POST ALL BONDS ASSOCIATED WITH THE SAME, AND COORDINATE WITH THE ENGINEER
- THE CONTRACTOR SHALL BE SOLELY RESPONSIBLE FOR JOB SITE SAFETY. THE CONTRACTOR SHALL PROVIDE TEMPORARY FENCING AND/OR BARRIERS AROUND ALL OPEN EXCAVATED AREAS IN ACCORDANCE WITH OSHA FEDERAL, STATE, AND LOCAL REQUIREMENTS.
- THE CONTRACTOR SHALL BE RESPONSIBLE FOR VERIFYING THAT THE PROPOSED IMPROVEMENTS SHOWN ON THE PLANS DO NOT CONFLICT WITH ANY KNOWN EXISTING OR OTHER PROPOSED IMPROVEMENTS. IF ANY CONFLICTS ARE DISCOVERED, THE CONTRACTOR SHALL NOTIFY THE OWNER AND THE ENGINEER PRIOR TO INSTALLATION OF ANY PORTION OF THE SITE WORK WHICH WOULD BE AFFECTED. NO FIELD ADJUSTMENTS IN THE LOCATION OF SITE ELEMENTS SHALL BE MADE WITHOUT THE ENGINEERS APPROVAL.
- 5. IF ANY DEVIATION OR ALTERATION OF THE WORK PROPOSED ON THESE DRAWINGS IS REQUIRED, THE CONTRACTOR SHALL IMMEDIATELY CONTACT AND COORDINATE ANY DEVIATIONS WITH THE ENGINEER AND OWNER.
- 6. ANY AREA OUTSIDE OF THE LIMIT OF WORK THAT IS DISTURBED SHALL BE RESTORED TO ITS ORIGINAL CONDITION AT NO ADDITIONAL COST TO THE OWNER.
- ALL SITE WORK SHALL MEET OR EXCEED THE SITE WORK SPECIFICATIONS PREPARED FOR THIS PROJECT.
- 8. ALL SIGNS SHALL BE REFLECTORIZED TYPE III SHEETING AND CONFORM WITH THE MANUAL OF UNIFORM TRAFFIC CONTROL DEVICES, LATEST REVISION.
- 9. ALL UTILITIES (LOCATION AND ELEVATION) DEPICTED SHALL BE CONSIDERED APPROXIMATE ONLY. BEFORE COMMENCING SITE WORK IN ANY AREA, CONTACT "DIG SAFE" AT 1-888-DIG-SAFE (1-888-344-7233) TO ACCURATELY LOCATE UNDERGROUND UTILITIES. ALL DAMAGE TO EXISTING UTILITIES OR STRUCTURES, AND THE COST TO REPAIR THE DAMAGES TO INITIAL CONDITIONS, AS SHOWN ON THE PLANS SHALL BE THE CONTRACTOR'S RESPONSIBILITY.
- 10. NO EXCAVATION SHALL BE DONE UNTIL COMPANIES ARE PROPERLY NOTIFIED IN ADVANCE. NOTE THAT NOT ALL EXISTING UNDERGROUND UTILITIES ARE SHOWN. IT IS THE CONTRACTOR'S RESPONSIBILITY TO CONTACT ALL RESPECTIVE UTILITY COMPANIES TO VERIFY AND LOCATE EXISTING UTILITIES.
- 11. AS OF JANUARY 1, 2009, ALL TRENCH EXCAVATION CONTRACTORS SHALL COMPLY WITH MASSACHUSETTS GENERAL LAWS CHAPTER 82A, TRENCH EXCAVATION SAFETY REQUIREMENTS, TO PROTECT THE GENERAL PUBLIC FROM UNAUTHORIZED ACCESS TO UNATTENDED TRENCHES. TRENCH EXCAVATION PERMIT REQUIRED. THIS APPLIES TO ALL TRENCHES ON PUBLIC AND PRIVATE PROPERTY
- 12. PRIOR TO OCCUPANCY PERMIT BEING ISSUED, AN AS-BUILT PLAN SHALL BE SUBMITTED TO THE ENGINEERING DIVISION IN BOTH DIGITAL FORMAT AND IN HARD COPY. THE PLAN SHOULD SHOW ALL UTILITIES AND FINAL GRADES, ANY EASEMENTS AND FINAL GRADING.
- 13. THE APPLICANT WILL HAVE TO APPLY FOR A STREET OPENING & UTILITIES CONNECTION PERMITS AS WELL AS A SIDEWALK CROSSING
- 14. CONTRACTOR SHALL PROVIDE A CONSTRUCTION MANAGEMENT PLAN FOR THIS PROJECT. AT A MINIMUM, IT MUST ADDRESS THE FOLLOWING: STAGING SITE FOR CONSTRUCTION EQUIPMENT, CONSTRUCTION MATERIALS, PARKING OF CONSTRUCTION WORKER'S VEHICLES, PHASING OF THE PROJECT WITH ANTICIPATED COMPLETION DATES AND MILESTONES, SAFETY PRECAUTIONS, EMERGENCY CONTACT PERSONNEL OF CONTRACTOR. IT SHALL ALSO ADDRESS ANY ANTICIPATED DEWATERING DURING CONSTRUCTION, SITE SAFETY & STABILITY, AND IMPACT TO ABUTTING PROPERTIES.

LAYOUT NOTES

- 1. ALL LINES ARE PERPENDICULAR OR PARALLEL TO THE LINES FROM WHICH THEY ARE MEASURED UNLESS OTHERWISE INDICATED.
- ACCESSIBLE RAMPS SHALL BE PER THE AMERICAN WITH DISABILITIES ACT (ADA) ACCESSIBILITY GUIDELINES AND CODE OF MASSACHUSETTS REGULATIONS (CMR) TITLE 521 OF THE ARCHITECTURAL ACCESS BOARD REGULATIONS.
- PRIOR TO COMMENCING WORK, THE CONTRACTOR SHALL PERFORM BENCHMARK FIELD LEVEL VERIFICATION AND COORDINATE LAYOUT CHECK. THE CONTRACTOR SHALL CONTACT PARE CORPORATION IF ANY DISCREPANCIES ARE FOUND.
- DIMENSIONS OF PARKING SPACES AND DRIVEWAYS ARE FROM FACE OF CURB TO FACE OF CURB. DIMENSIONS FROM BUILDING ARE FROM FACE OF BUILDING TO FACE OF CURB.
- 5. ALIGN WALKWAYS ON DOORWAYS THEY SERVE TO PROVIDE MINIMUM REQUIRED MANEUVERING CLEARANCE IN ACCORDANCE WITH THE AMERICAN WITH DISABILITIES ACT (ADA) ACCESSIBILITY GUIDELINES AND CODE OF MASSACHUSETTS REGULATIONS (CMR) TITLE 521 OF THE ARCHITECTURAL ACCESS BOARD REGULATIONS.

DEMOLITION NOTES

- 1. THE CONTRACTOR SHALL COORDINATE ALL DEMOLITION OF STRUCTURES, PAVEMENT AND CONCRETE MATERIALS, AND UTILITIES WITH APPROPRIATE PROPOSED SITE GENERAL, GRADING, UTILITY, AND LANDSCAPING DRAWINGS.
- ALL NOTED UTILITIES TO BE REMOVED AND DISPOSED OF, RELOCATED OR CAPPED REPRESENT ALL KNOWN SITE CONDITIONS TO BE DEMOLISHED. THE CONTRACTOR SHALL COORDINATE ALL UNFORESEEN CONDITIONS WITH THE PROJECT ENGINEER, OWNER AND/OR RESPECTIVE UTILITY COMPANIES PRIOR TO PROCEEDING WITH WORK.
- WATER, SEWER, DRAINAGE, GAS, AND OTHER SITE UTILITIES SERVICING THE EXISTING FACILITIES ARE TO REMAIN ACTIVE THROUGHOUT CONSTRUCTION.
- 4. THERE SHALL BE NO INTERRUPTION OF UTILITY SERVICES DURING THE CONSTRUCTION OPERATION WITHOUT APPROVAL OF THE OWNER.

GRADING AND UTILITY NOTES

- UNDERGROUND UTILITIES DEPICTED WERE COMPILED FROM AVAILABLE RECORD PLANS AND SHALL BE CONSIDERED APPROXIMATE ONLY. BEFORE COMMENCING SITE WORK IN ANY AREA, CONTACT "DIG SAFE" AT 1-888-DIG-SAFE (1-888-344-7233) TO ACCURATELY LOCATE UNDERGROUND UTILITIES. ANY DAMAGE TO EXISTING UTILITIES OR STRUCTURES DEPICTED OR NOT DEPICTED ON THE PLANS SHALL BE THE CONTRACTOR'S RESPONSIBILITY. COSTS TO REPAIR SUCH DAMAGES SHALL BE THE CONTRACTOR'S RESPONSIBILITY. NO EXCAVATION SHALL BE DONE UNTIL UTILITY COMPANIES ARE PROPERLY NOTIFIED.
- 2. ALL WORK PERFORMED AND ALL MATERIALS FURNISHED SHALL CONFORM WITH THE LINES AND GRADES ON THE PLANS AND SITE WORK SPECIFICATIONS.
- 3. AT ALL LOCATIONS WHERE EXISTING CURBING OR PAVEMENT ABUT NEW CONSTRUCTION, THE EDGE OF THE EXISTING CURB OR PAVEMENT SHALL BE SAW CUT TO A CLEAN, SMOOTH EDGE. BLEND NEW PAVEMENT AND CURBS SMOOTHLY INTO EXISTING BY MATCHING LINES, GRADES AND JOINTS.
- 4. ALL UTILITY COVERS, GRATES, ETC. SHALL BE ADJUSTED TO BE FLUSH WITH THE SURROUNDING SURFACE OR PAVEMENT FINISH GRADE. RIM ELEVATIONS OF STRUCTURES AND MANHOLES ARE APPROXIMATE. FINAL ELEVATIONS ARE TO BE SET FLUSH AND CONSISTENT WITH THE
- 5. THE CONTRACTOR SHALL MAKE ALL ARRANGEMENTS FOR THE ALTERATION OF PRIVATE UTILITIES BY THE UTILITY COMPANIES, AS
- WHERE AN EXISTING UTILITY IS FOUND TO CONFLICT WITH THE PROPOSED WORK, THE LOCATION, ELEVATION AND SIZE OF THE UTILITY SHALL BE ACCURATELY DETERMINED WITHOUT DELAY BY THE CONTRACTOR AND THE INFORMATION SHALL BE PROVIDED ON A SKETCH TO SCALE OF THE EXISTING UTILITY WITH TIES TO KNOWN POINTS, PHOTOS AND FURNISHED TO THE ENGINEER FOR RESOLUTION.
- 7. THE CONTRACTOR SHALL PROTECT ALL UNDERGROUND DRAINAGE, SEWER AND UTILITY FACILITIES FROM EXCESSIVE VEHICULAR LOADS DURING CONSTRUCTION. ANY DAMAGE TO THESE FACILITIES RESULTING FROM CONSTRUCTION LOADS SHALL BE RESTORED TO ORIGINAL
- 8. GAS, ELECTRIC, AND COMMUNICATIONS ROUTING ARE SUBJECT TO REVIEW AND APPROVAL BY APPROPRIATE UTILITY COMPANIES.
- DURING CONSTRUCTION OPERATIONS, THE CONTRACTOR SHALL PROTECT EXISTING UTILITIES BY PROVIDING TEMPORARY SUPPORTS OR SHEETING AS REQUIRED AT NO ADDITIONAL COST TO THE OWNER.
- 10. ALL GRAVITY SANITARY PIPING SHALL BE SDR-35 PVC. ALL SEWER CONSTRUCTION SHALL CONFORM TO THE TOWN OF NEWTON UTILITIES DIVISION STANDARDS AND SPECIFICATIONS.
- 11. ALL WATER LINE BENDS AND TEES SHALL BE REINFORCED WITH THRUST BLOCKS. ALL WATER DISTRIBUTION PIPING AND FITTINGS MUST ADHERE TO THE TOWN OF NEWTON UTILITIES DIVISION STANDARDS AND SPECIFICATIONS AND SHALL BE INSPECTED BEFORE, DURING, AND AFTER CONSTRUCTION PRIOR TO TAPPING THE SERVICE MAIN.
- 12. EXCAVATION REQUIRED WITHIN THE PROXIMITY OF EXISTING UTILITY LINES SHALL BE DONE BY HAND. CONTRACTOR SHALL REPAIR ANY DAMAGE TO EXISTING UTILITY LINES OR STRUCTURES INCURRED DURING CONSTRUCTION OPERATIONS AT NO COST TO THE OWNER.
- 13. PITCH EVENLY BETWEEN SPOT GRADES. ALL PAVED AREAS MUST PITCH TO DRAIN AT A MIN. OF 1/8" PER FOOT UNLESS SPECIFIED.
- 14. THE PROPOSED WALKWAYS SHALL HAVE A MAXIMUM CROSS SLOPE OF 2% AND A MAXIMUM RUNNING SLOPE OF 5% AS SHOWN ON CONSTRUCTION DETAILS AND GRADING PLAN.
- 15. THE NEW SEWER SERVICE AND/OR STRUCTURES SHALL BE PRESSURE TESTED OR VIDEOTAPED AFTER FINAL INSTALLATION IS COMPLETE. METHOD OF FINAL INSPECTION SHALL BE DETERMINED SOLELY BY THE CONSTRUCTION INSPECTOR FROM THE CITY ENGINEERING DIVISION. THE SEWER SERVICE WILL NOT BE ACCEPTED UNTIL ONE OF THE TWO METHODS STATED ABOVE IS COMPLETED.
- 16. THE CONTRACTOR NEEDS TO NOTIFY THE ENGINEERING DIVISION 48-HOURS IN ADVANCE AND SCHEDULE AN APPOINTMENT TO HAVE THE DRAINAGE SYSTEM, WATER & SEWER SERVICES INSPECTED. THE SYSTEM & UTILITIES MUST BE FULLY EXPOSED FOR THE INSPECTOR. ONCE THE INSPECTOR IS SATISFIED, THE SYSTEM & UTILITIES MAY THEN BE BACK FILLED.
- 17. ALL NEW SEWER SERVICE AND/OR STRUCTURES SHALL BE PRESSURE TESTED OR VIDEOTAPED AFTER FINAL INSTALLATION IS COMPLETE. METHOD OF FINAL INSPECTION SHALL BE DETERMINED SOLELY BY THE CONSTRUCTION INSPECTOR FROM THE CITY ENGINEERING DIVISION. ALL SEWER MANHOLES SHALL BE VACUUM TESTED IN ACCORDANCE WITH THE CITY'S CONSTRUCTION STANDARDS & SPECIFICATIONS. THE SEWER SERVICE WILL NOT BE ACCEPTED UNTIL ONE OF THE TWO METHODS STATED ABOVE IS COMPLETED. ALL TESTING MUST BE WITNESSED BY A REPRESENTATIVE OF THE ENGINEERING DIVISION. A CERTIFICATE OF OCCUPANCY WILL NOT BE RECOMMENDED UNTIL THIS TEST IS COMPLETED AND A WRITTEN REPORT IS RECEIVED BY THE CITY ENGINEER.
- ALL SEWER MANHOLES SHALL BE VACUUM TESTED IN ACCORDANCE WITH THE CITY'S CONSTRUCTION STANDARDS & SPECIFICATIONS. THE SEWER SERVICE WILL NOT BE ACCEPTED UNTIL ONE OF THE TWO METHODS STATED ABOVE IS COMPLETED. ALL TESTING MUST BE WITNESSED BY A REPRESENTATIVE OF THE ENGINEERING DIVISION. A CERTIFICATE OF OCCUPANCY WILL NOT BE RECOMMENDED UNTIL THIS TEST IS COMPLETED AND A WRITTEN REPORT IS RECEIVED BY THE CITY ENGINEER
- 19. FIRE FLOW TESTING IS REQUIRED FOR THE PROPOSED FIRE SUPPRESSION SYSTEM. THE APPLICANT MUST COORDINATE THIS TEST WITH BOTH THE NEWTON FIRE DEPARTMENT AND THE UTILITIES DIVISION; REPRESENTATIVES OF EACH DEPARTMENT SHALL WITNESS THE TESTING; TEST RESULTS SHALL BE SUBMITTED IN A WRITE REPORT. HYDRAULIC CALCULATION SHALL BE SUBMITTED TO THE NEWTON FIRE
- 20. ALL WATER CONNECTIONS SHALL BE CHLORINATED & PRESSURE TESTED IN ACCORDANCE WITH AWWA AND THE CITY OF NEWTON CONSTRUCTION STANDARDS AND SPECIFICATIONS PRIOR TO OPENING THE CONNECTION TO EXISTING PIPES.
- 21. FINALIZED UTILITY CONNECTION PLAN REFLECTING THE ABOVE CHANGES THAT MEETS THE MINIMAL DESIGN STANDARDS OF THE CITY OF NEWTON MUST BE SUBMITTED FOR APPROVAL BY THE CONTRACTOR OF RECORD WITH APPROPRIATE BONDS & INSURANCE. THE ENGINEERING DIVISION MAKES NO REPRESENTATIONS AND ASSUMES NO RESPONSIBILITY FOR THE DESIGN(S) IN TERMS OF SUITABILITY FOR THE PARTICULAR SITE CONDITIONS OR OF THE FUNCTIONABILITY OR PERFORMANCE OF ANY ITEMS CONSTRUCTED IN ACCORDANCE WITH THE DESIGN(S). THE CITY OF NEWTON ASSUMES NO LIABILITIES FOR DESIGN ASSUMPTION, ERROR OR OMISSIONS BY THE ENGINEER OF

EROSION AND SEDIMENTATION CONTROL NOTES - MASSACHUSETTES

- THE CONTRACTOR SHALL BE RESPONSIBLE FOR ESTABLISHING AND MAINTAINING ALL TEMPORARY SOIL EROSION AND SEDIMENT CONTROLS IN ACCORDANCE WITH THE ENVIRONMENTAL PROTECTION AGENCY'S (EPA) NATIONAL POLLUTANT DISCHARGE ELIMINATION SYSTEM (NPDES) CONSTRUCTION GENERAL PERMIT (CGP) AND THE CONTRACT DOCUMENTS.
- THE CONTRACTOR SHALL PREPARE AND SUBMIT A STORMWATER POLLUTION PREVENTION PLAN (SWPPP) PRIOR TO CONSTRUCTION.
- THE CONTRACTOR SHALL PREPARE AND SUBMIT AN ELECTRONIC NOTICE OF INTENT (eNOI) WITH THE EPA IN ACCORDANCE WITH THE NDPES PERMIT REQUIREMENTS PRIOR TO CONSTRUCTION.
- SOIL EROSION AND SEDIMENTATION CONTROLS SHALL BE PROVIDED IN ACCORDANCE WITH THE "MASSACHUSETTS EROSION AND SEDIMENT CONTROL GUIDELINES FOR URBAN AND SUBURBAN AREAS" AND THE NOTES AND DETAILS SHOWN IN THIS PLAN SET.
- THE EROSION AND SEDIMENTATION CONTROLS SHOWN ON THE PLANS ARE INTENDED TO REPRESENT THE MINIMUM CONTROLS NECESSARY TO MEET ANTICIPATED SITE CONDITIONS. ADDITIONAL MEASURES SHALL BE IMPLEMENTED AS CONDITIONS WARRANT OR AS DIRECTED BY THE OWNER OR OWNER'S REPRESENTATIVE.
- REQUIRED PERIMETER CONTROL SHALL BE PROPERLY ESTABLISHED, CLEARLY VISIBLE AND IN OPERATION PRIOR TO INITIATING ANY LAND CLEARING ACTIVITY AND/OR OTHER CONSTRUCTION RELATED WORK. SUCH FACILITIES SHALL REPRESENT THE LIMIT OF WORK. WORKERS SHALL BE INFORMED THAT NO CONSTRUCTION ACTIVITY IS TO OCCUR BEYOND THE LIMIT OF WORK AT ANY TIME THROUGHOUT THE CONSTRUCTION PERIOD.
- AS FEASIBLE, CONSTRUCTION SHALL BE PHASED TO LIMIT THE AREA OF EXPOSED SOIL AND THE DURATION OF EXPOSURE. ALL DISTURBED AREAS SHALL BE TEMPORARILY AND/OR PERMANENTLY STABILIZED WITHIN 14 DAYS FOLLOWING COMPLETION OF GRADING ACTIVITIES.
- THE CONTRACTOR SHALL INSPECT AND MAINTAIN ALL EROSION AND SEDIMENTATION CONTROL MEASURES IN ACCORDANCE WITH THE CONTRACT DOCUMENTS.
- EROSION AND SEDIMENTATION CONTROL MEASURES SHALL BE INSPECTED AND MAINTAINED ON A WEEKLY BASIS AND AFTER EACH STORM EVENT OF 0.25 INCH OR GREATER DURING CONSTRUCTION TO ENSURE THAT THE EROSION CONTROL BARRIERS ARE INTACT.
- CLEAN AND MAINTAIN SEDIMENTATION CONTROL BARRIERS WHEN SEDIMENT ACCUMULATES TO ONE HALF THE HEIGHT OF THE BARRIER. MATERIAL COLLECTED FROM THE SEDIMENTATION BARRIER SHALL BE REMOVED AS NECESSARY AND DISPOSED IN AN UPLAND AREA.
- 11. THE CONTRACTOR SHALL MAINTAIN A SUFFICIENT RESERVE OF VARIOUS EROSION CONTROL MATERIALS ONSITE AT ALL TIMES FOR EMERGENCY PURPOSES OR ROUTINE MAINTENANCE.
- 12. THE CONTRACTOR SHALL SCHEDULE HIS WORK TO ALLOW THE FINISHED SUB GRADE ELEVATIONS TO DRAIN PROPERLY WITHOUT PUDDLING. SPECIFICALLY, ALLOW WATER TO ESCAPE WHERE PROPOSED CURB MAY RETAIN RUNOFF PRIOR TO PAVING. PROVIDE TEMPORARY POSITIVE DRAINAGE, AS REQUIRED, TO STABILIZED DISCHARGE POINTS.
- SOIL AND OTHER MATERIALS RESULTING FROM SITE CLEARING MAY BE RECYCLED AND/OR REUSED ON THE SITE AS APPROPRIATE. WASTE MATERIALS SHALL BE REMOVED FROM THE SITE.
- 14. CRUSHED STONE CONSTRUCTION ENTRANCES SHALL BE ESTABLISHED AT ALL POINTS OF INGRESS AND EGRESS.
- TEMPORARY DIVERSIONS (TD) MAY CONSIST OF A DITCH OR SWALE, OR MAY BE ACHIEVED USING WOOD CHIP PILES, COIR LOGS, OR SIMILAR MATERIALS.
- TEMPORARY SEDIMENT TRAPS (TST) AND TEMPORARY SWALES (TS) SHALL BE SIZED BY THE CONTRACTOR USING THE PARAMETERS CONTAINED IN THE MASSACHUSETTS EROSION AND SEDIMENT CONTROL GUIDELINES.
- DUST SHALL BE CONTROLLED BY SPRINKLING OR OTHER APPROVED METHODS AS NECESSARY, OR AS DIRECTED BY THE OWNER OR OWNER'S REPRESENTATIVE.
- CATCH BASINS AND STORM DRAINS SHALL BE PROTECTED WITH HAY BALES OR SEDIMENT BAGS IN PAVED AREAS UNTIL CONTRIBUTING AREA IS PERMANENTLY STABILIZED.
- DEWATERING WASTEWATER PUMPED FROM EXCAVATIONS SHALL BE CONVEYED BY HOSE TO AN UPLAND AREA AND DISCHARGED INTO A DEWATERING BASIN, HAY BALE CORRALS, OR SEDIMENTATION BAGS.
- 20. CONSTRUCTION SITE WASTE MATERIALS SHALL BE PROPERLY CONTAINED ONSITE AND DISPOSED OFF SITE AT A LOCATION IN ACCORDANCE WITH THE LOCAL AND STATE REGULATIONS.
- 21. RIPRAP OR OTHER ENERGY DISSIPATERS SHALL BE USED WHERE NECESSARY TO CONTROL EROSION.
- 22. ANY EQUIPMENT THAT IS NOT READILY MOBILE (TRACK MACHINERY) SHALL BE PARKED WITHIN THE PROJECT LIMIT OF DISTURBANCE, LARGE AND/OR BULKY MATERIALS SHALL BE STORED SUCH THAT THEY DO NOT INTERFERE WITH THE ONGOING CONSTRUCTION ACTIVITIES OR EROSION CONTROL MEASURES.
- 23. NEWLY VEGETATED AREAS SHALL BE REGULARLY INSPECTED AND MAINTAINED TO ENSURE THE ESTABLISHMENT OF STABLE VEGETATED SURFACES.
- 24. THE CONTRACTOR SHALL NOT REMOVE ANY COMPOST FILTER SOCKS OR OTHER EROSION CONTROLS UNTIL THE CONTRIBUTING AREA IS PERMANENTLY STABILIZED.
- 25. ALL DRAINAGE STRUCTURES SHALL BE CLEARED OF ACCUMULATED SEDIMENT PRIOR TO ACCEPTANCE OF THE FINAL PROJECT. THE CONTRACTOR SHALL SCHEDULE HIS WORK TO ALLOW THE FINISHED SUB GRADE ELEVATIONS TO DRAIN PROPERLY WITHOUT PONDING. SPECIFICALLY, ALLOW WATER TO ESCAPE WHERE PROPOSED CURB MAY RETAIN RUNOFF PRIOR TO APPLICATION OF SURFACE PAVING. PROVIDE TEMPORARY POSITIVE DRAINAGE, AS REQUIRED, TO STABILIZED DISCHARGE POINTS.
- 26. INSTALLATION OF THE EROSION CONTROL BARRIERS AS ILLUSTRATED IS INTENDED TO REPRESENT THE MINIMUM SEDIMENTATION CONTROL FACILITIES NECESSARY TO MEET ANTICIPATED SITE CONDITIONS, ADDITIONAL EROSION CONTROL MEASURES SHALL BE IMPLEMENTED AS CONDITIONS WARRANT OR AS DIRECTED BY THE OWNER OR OWNER'S
- 27. ALL DISTURBED AREAS SHALL BE STABILIZED WITHIN 14 DAYS UPON COMPLETION OF WORK IN THAT AREA.

STATE RIGHT-OF-WAY NOTES

- 1. ALL WORK TO BE PERFORMED WITHIN THE COMMON WEALTH OF MASSACHUSETTS PUBLIC RIGHT-OF-WAY (ROW) SHALL CONFORM TO THE MASSDOT STANDARD SPECIFICATIONS FOR HIGHWAYS AND BRIDGE CONSTRUCTION, 1988 EDITION OR LATEST REVISION, AND THE MASSACHUSETTS DEPARTMENT OF TRANSPORTATION CONSTRUCTION STANDARD DETAILS.
- THE CONTRACTOR SHALL APPLY FOR AND OBTAIN A UTILITY PERMIT FROM THE MASSDOT FOR UTILITY WORK WITHIN THE PUBLIC ROW AND MAKE ALL NECESSARY CONSTRUCTION NOTIFICATIONS, PAY ALL FEES AND POST ALL BONDS ASSOCIATED WITH THE SAME, AND COORDINATE WITH THE ENGINEER AND OWNER'S REPRESENTATIVE AS REQUIRED.
- THE CONTRACTOR SHALL PREPARE A TRANSPORTATION MANAGEMENT PLAN INCLUDING A TEMPORARY TRAFFIC CONTROL PLAN AS REQUIRED FOR THE MASSDOT UTILITY PERMIT APPLICATION AT NO ADDITIONAL EXPENSE TO THE OWNER.
- 4. ALL TEMPORARY TRAFFIC CONTROLS SHALL BE IN ACCORDANCE WITH THE "MANUAL OF UNIFORM TRAFFIC CONTROL DEVICES" (MUTCD), LATEST REVISION.

CONSTRUCTION NOTES - MASSDOT STANDARDS

(106.3.0) = METHOD OF SETTING VERTICAL CURB - M.A. STD. 106.3.0

107.6.0 = WHEELCHAIR RAMPS FOR ONE CONTINUOUS DIRECTION OF PEDESTRIAN TRAVEL - M.A. STD. 107.6.0

(107.6.5) = DETECTABLE WARNING PANEL FOR WHEELCHAIR RAMPS - M.A. STD. 107.6.5

(201.4.0) = PRECAST CONCRETE CATCH BASIN - M.A. STD. 201.4.0

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PROJECT NAME

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REVISIONS

DRAWING TITLE

NOTES

DRAWING INFORMATION



DRAWING NUMBER

Boston, MA 02210 (617) 350 0450 PROJECT NAME **Active Living** 345 Walnut Street. Newton, MA. 02460 City of Newton PROJECT TEAM **CIVIL ENGINEER** Pare Corporation 0 Lincoln Rd, Suite 210 Foxboro, MA 02035 Tel: 508.543.1755 CIVIL ENGINEER Kyle Zick Landscape Architecture, Inc. 136 Bromfield St, Suite 202 Boston, MA 02108 Tel: 617.451.1018 REVISIONS DRAWING TITLE **LEGEND** DRAWING INFORMATION DRAWING NUMBER

DWP

DYL

DYLEx

DBYL

DW

DWL

DWY

EMB

EMH

ELEV (or EL.)

DETECTABLE WARNING PAVER (SEE DETAIL)

STEADY DON'T WALK - PORTLAND ORANGE

DOTTED YELLOW LINE EXTENSION

DOTTED YELLOW LINE

DOUBLE YELLOW LINE

DOTTED WHITE LINE

ELECTRIC MANHOLE

DRIVEWAY

ELEVATION

EMBANKMENT

PVCH

PVI

PVT

PVMT

PWW

QPA

R&D

R&R

R&S

R=X'

POLYVINYL CHLORIDE

PAVED WATER WAY

REMOVE AND DISPOSE

REMOVE AND RESET

REMOVE AND STACK

PAVEMENT

RADIUS

POINT OF VERTICAL INTERSECTION

POINT OF VERTICAL TANGENCY

QUALIFYING PERVIOUS AREA

<u>GENERAL</u> CMR

MASSDEP

WPM

YD

4DY

12W

X-SECT

CODE OF MASSACHUSETTS REGULATIONS

MASSACHUSETTS DEPARTMENT OF ENVIRONMENTAL PROTECTION

4" DOUBLE YELLOW EPOXY RESIN PAVEMENT MARKING

4" SOLID WHITE EPOXY RESIN PAVEMENT MARKING

12" SOLID WHITE EPOXY RESIN PAVEMENT MARKING

MASSDOT MASSACHUSETTS DEPARTMENT OF TRANSPORTATION

MASSACHUSETTS STANDARD

MASSACHUSETTS ABBREVIATIONS


WATER PAINT MARK


CROSS SECTION

YARD DRAIN

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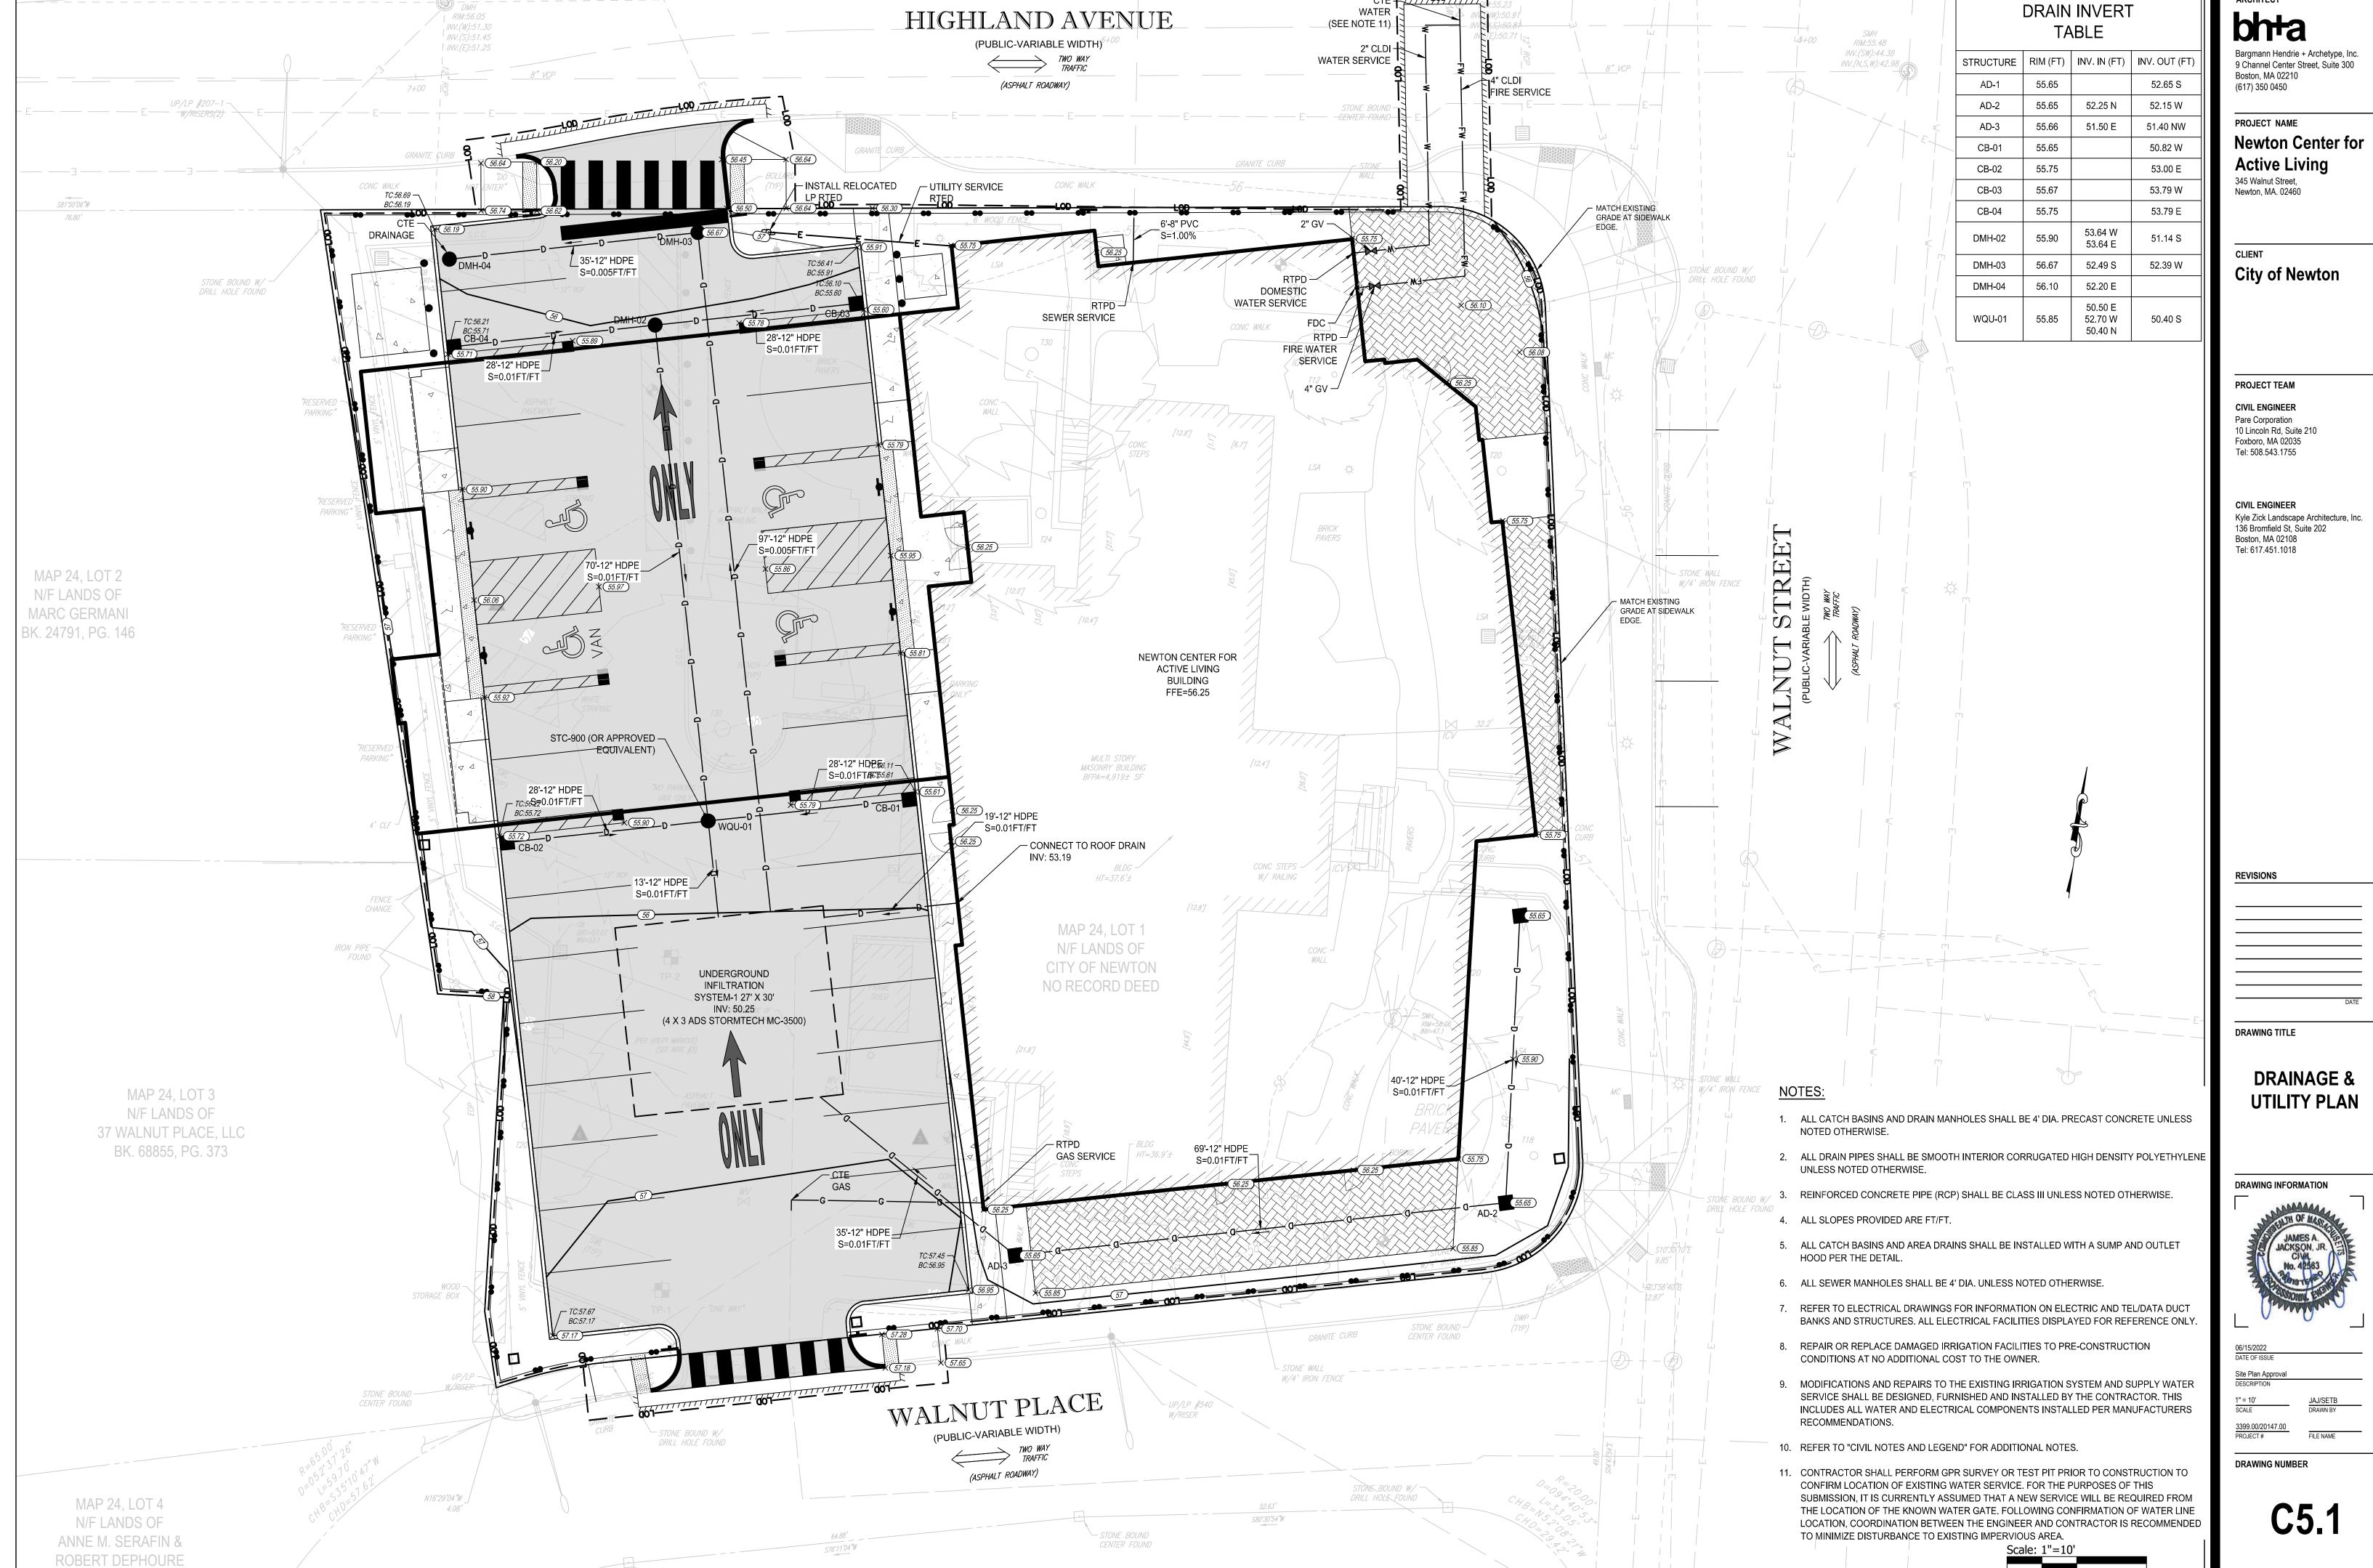


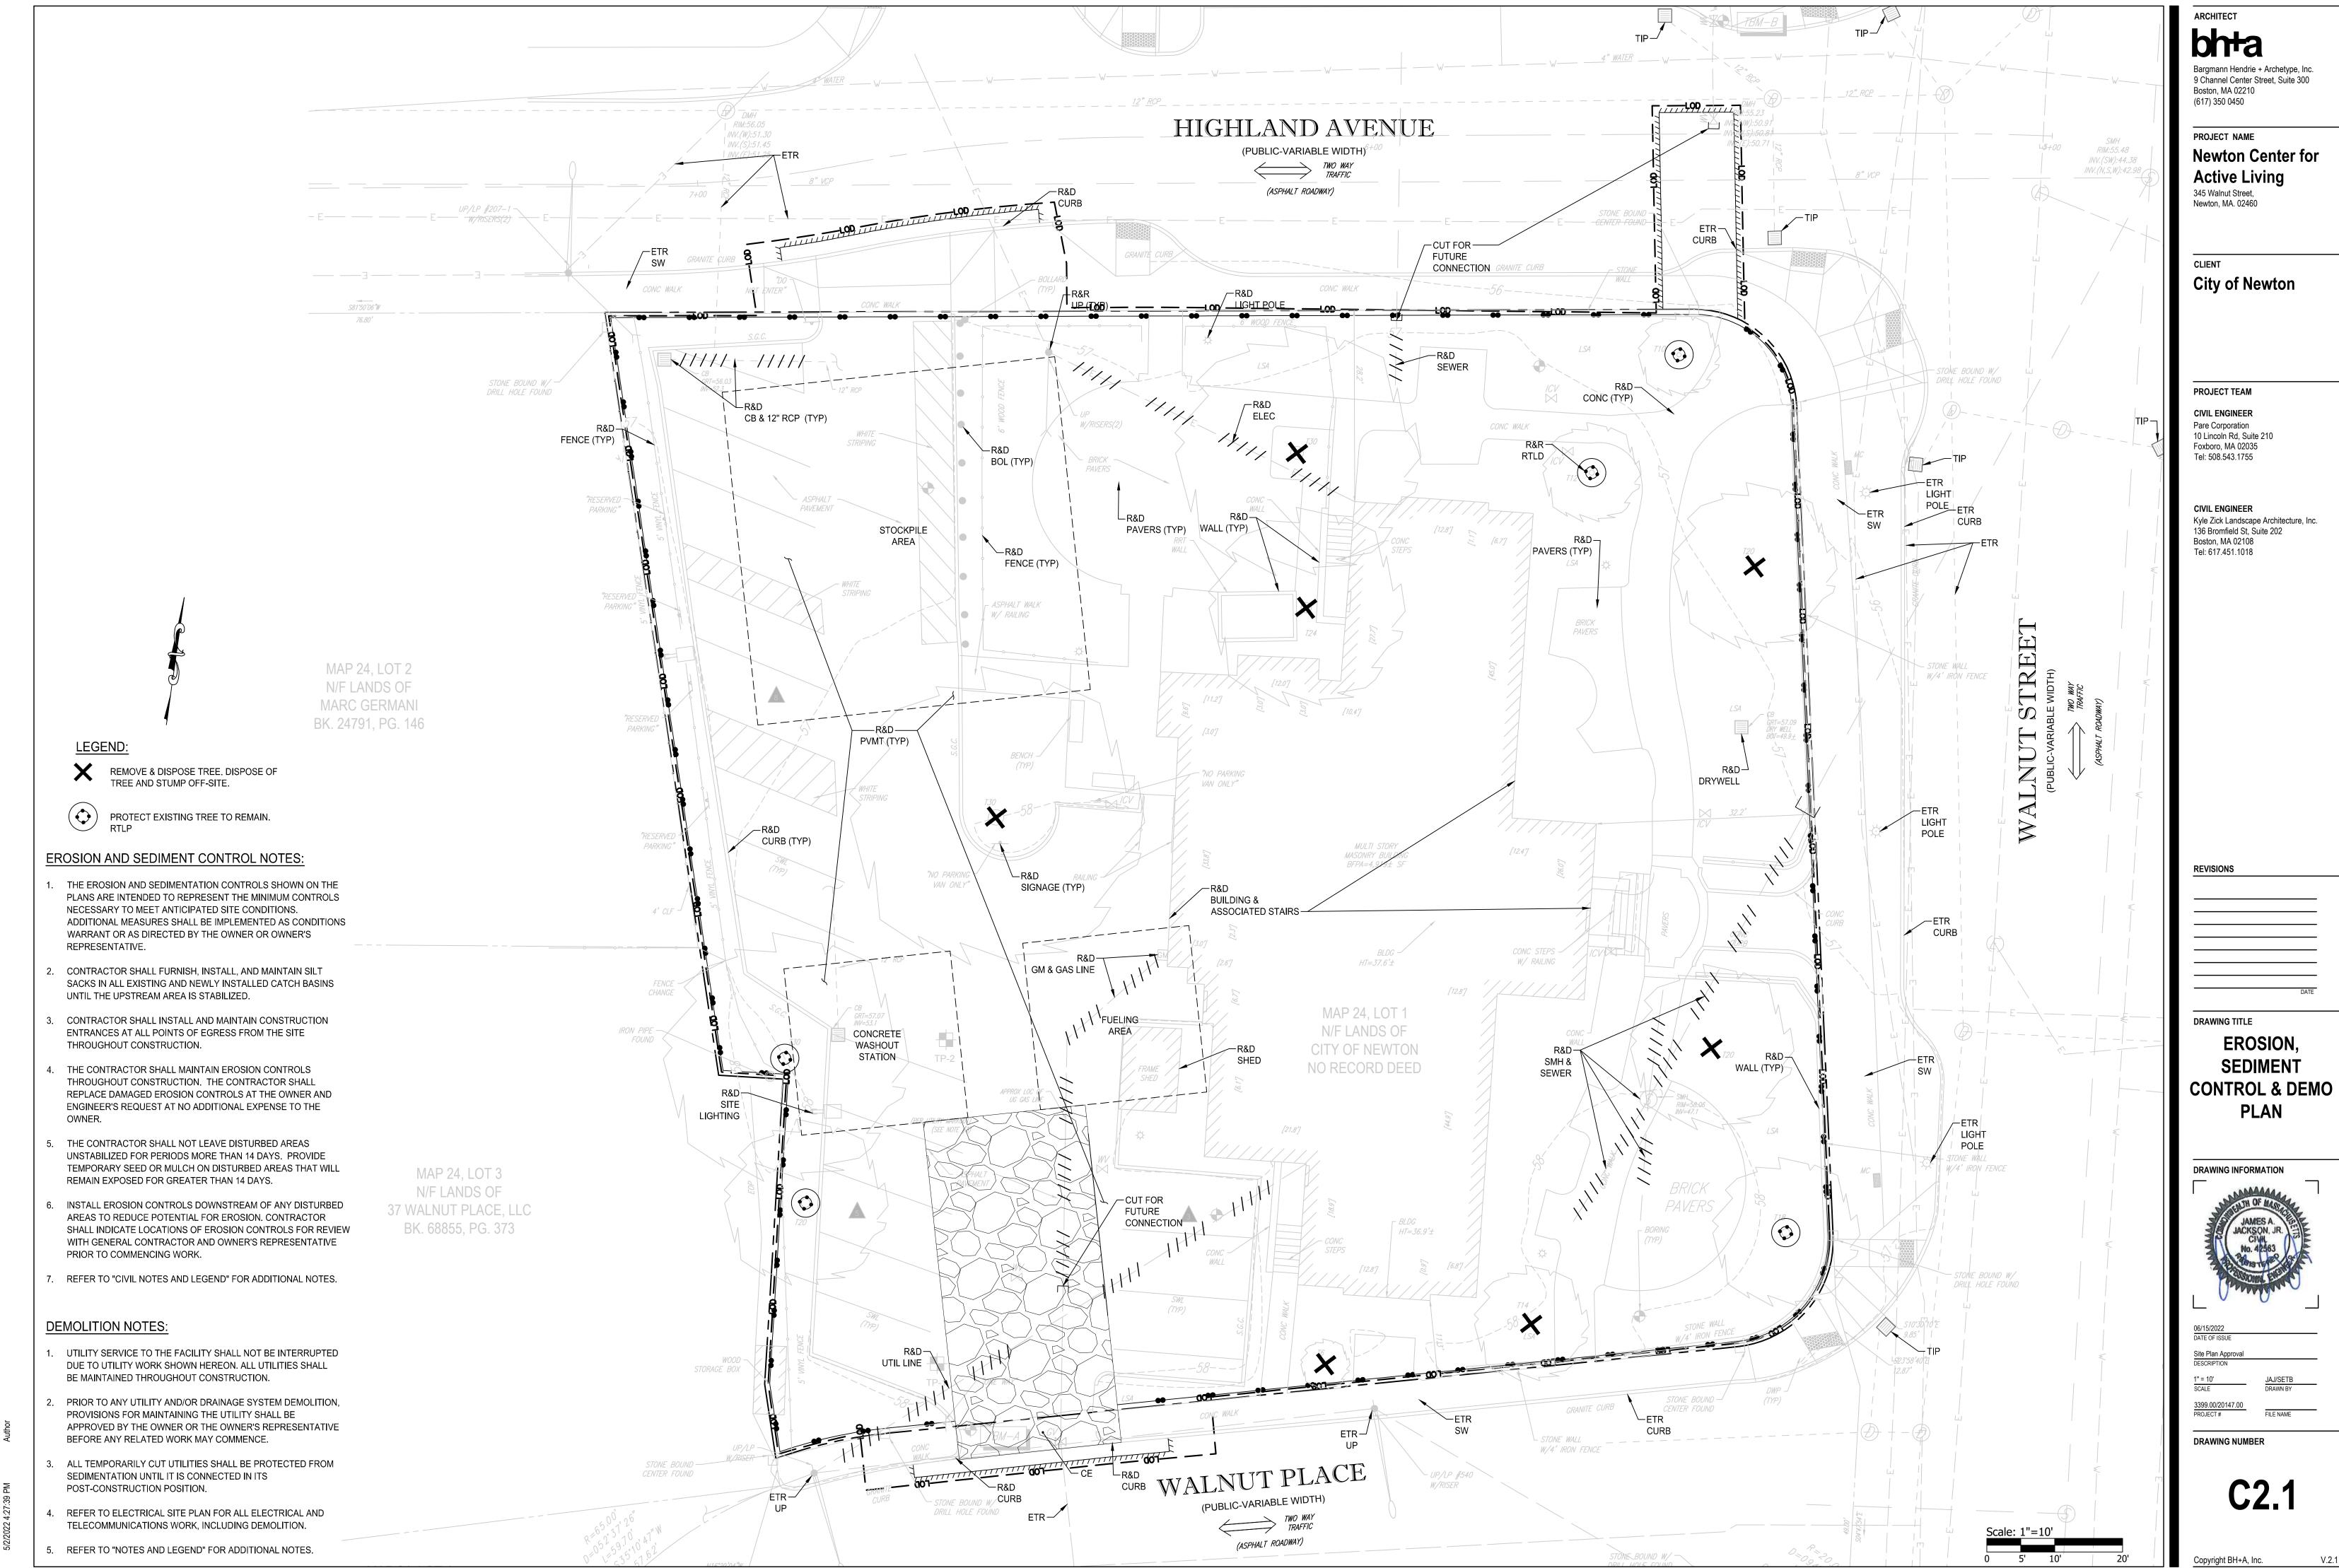

- STONE BOUND W/
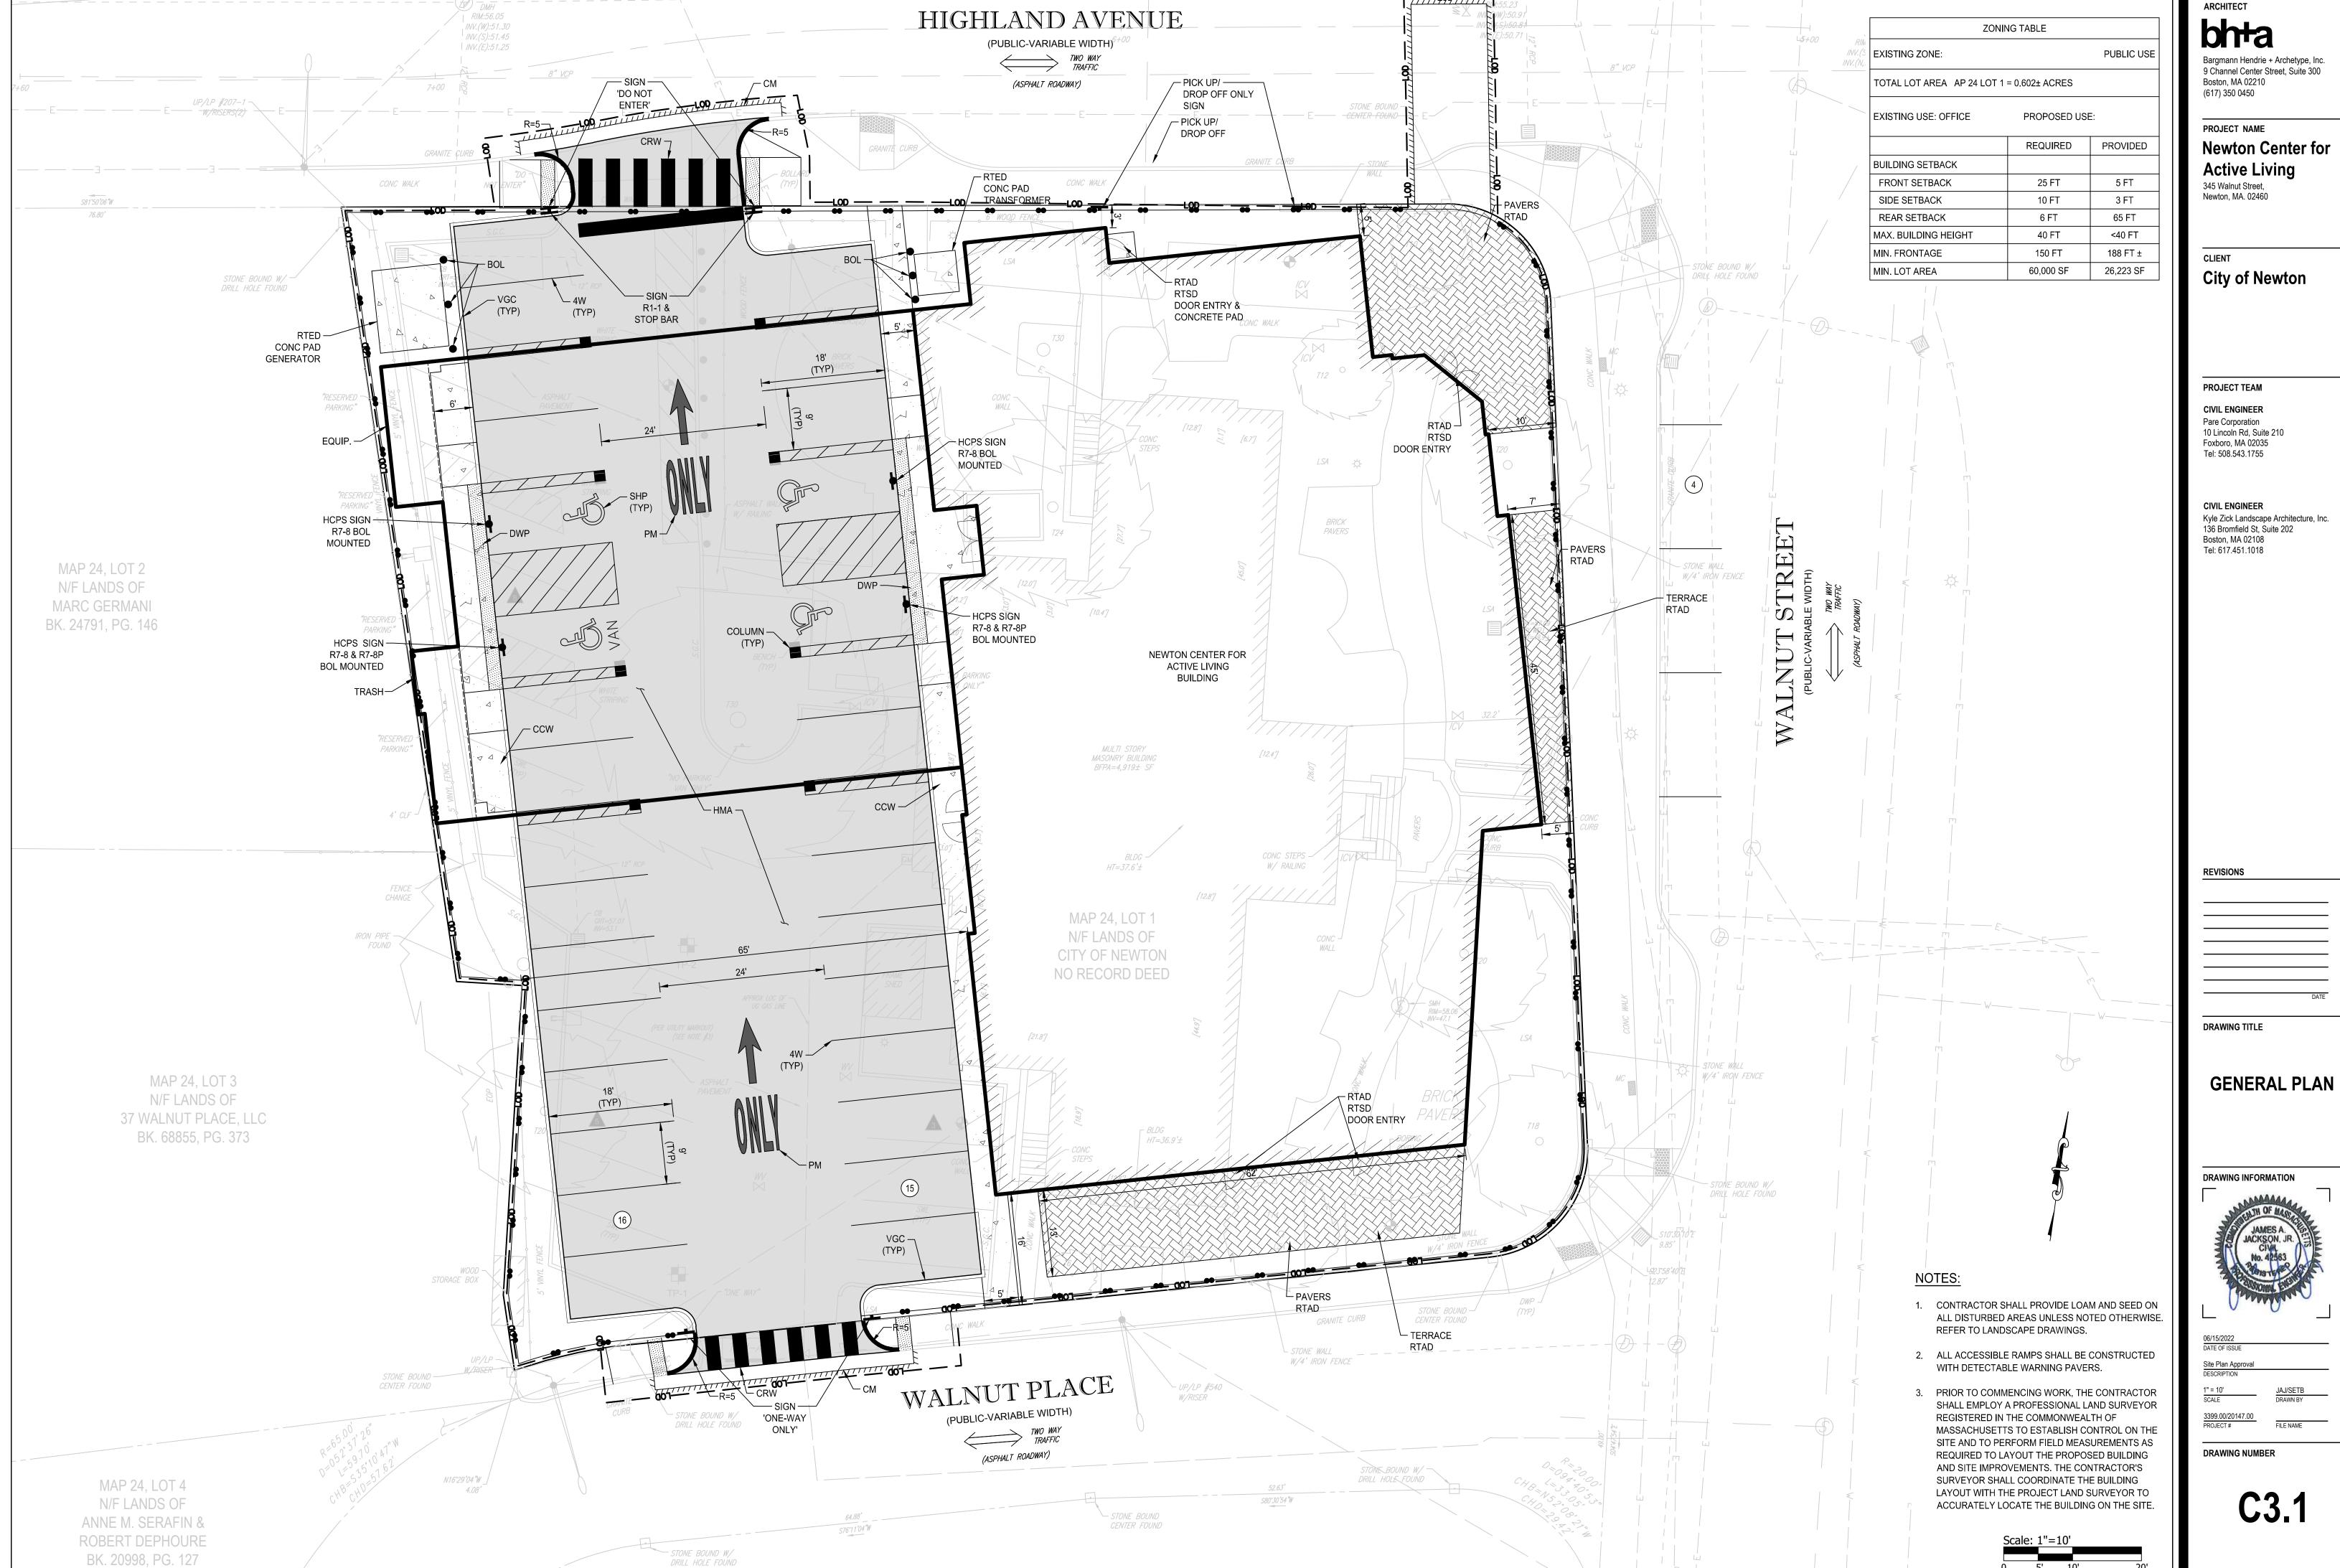
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BK. 20998. PG. 127




- STONE BOUND W/

BK. 20998, PG. 127

NOTES:

- 1. COMPOST/ SOIL/ ROCK/ SEED FILL TO MEET APPLICATION REQUIREMENTS.
- 2. COMPOST MATERIAL TO BE REMOVED OR DISPERSED ON SITE AS DETERMINED BY ENGINEER.
- 3. IF SOCK NETTING MUST BE JOINED, FIT BEGINNING OF NEW SOCK OVER END OF OLD SOCK, OVERLAPPING BY 2 FEET AND STACK OVERLAP. IF SOCK NETTING IS NOT JOINED, OVERLAP OLD SOCK WITH NEW ONE BY MINIMUM OF 2 FEET.

COMPOST FILTER SOCK DETAIL NOT TO SCALE

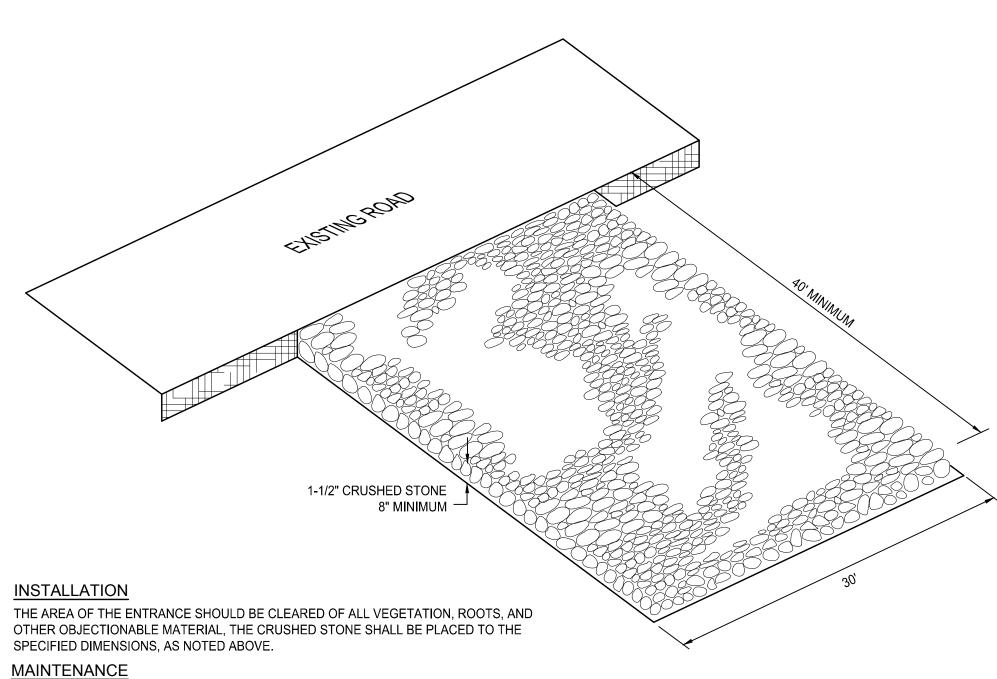

THE ENTRANCE SHALL BE MAINTAINED IN A CONDITION WHICH WILL PREVENT TRACKING OR FLOWING OF SEDIMENTS ONTO PUBLIC RIGHT-OF-WAYS. THIS WILL REQUIRE PERIODIC TOP DRESSING WITH ADDITIONAL STONE, OR ADDITIONAL LENGTH, AS CONDITIONS DEMAND, AND REPAIR, AND / OR CLEANOUT OF ANY MEASURES USED TO TRAP SEDIMENT. ALL SEDIMENT SPILLED, DROPPED, WASHED OR TRACKED ONTO PUBLIC RIGHT-OF-WAYS MUST BE REMOVED IMMEDIATELY.

LOCATION

SEE PROJECT PLANS FOR LOCATION OF CONSTRUCTION ENTRANCE.

CONSTRUCTION ENTRANCE PROTECTION STONE STABILIZATION PAD


NOT TO SCALE

ZONE. PENALTIES ASSESSED FOR DAMAGE TO TREES." 2. REMOVABLE SECTION OF FENCE WITH FENCE POSTS SET IN STAND 3. 40LB SAND BAGS, OR EQUAL NOTES A. SIGNS SHALL BE PLACED AT 30'-0" INTERVALS. B. SIGNS SHALL HAVE BOTH ENGLISH AND SPANISH TRANSLATION. C. REFER TO "DEMOLITION PLANS" FOR LOCATIONS OF TREE PROTECTION. **EXISTING** GRADE -

LEGEND


1. SIGN - "KEEP OUT: SITE PROTECTION

DRIPLINE TREE PROTECTION FENCE - SURFACE NOT TO SCALE

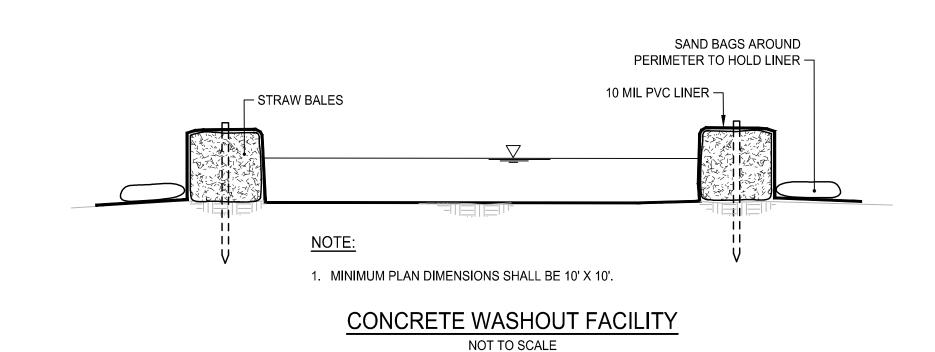


GRASS SEED PER R.I. STD. M.18.10.4 COMMON BORROW COMPACTED SUBGRADE

LOAM & SEED DETAIL NOT TO SCALE

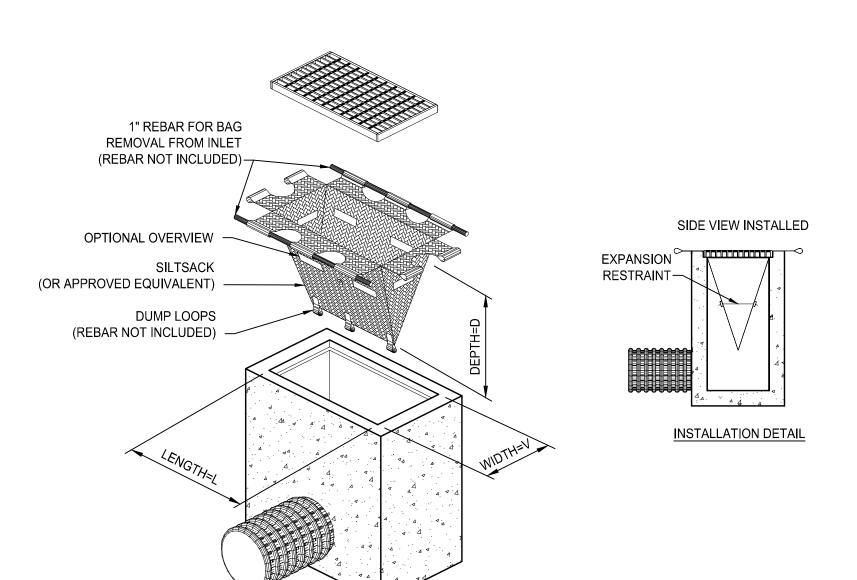

TEMPORARY INLET PROTECTION

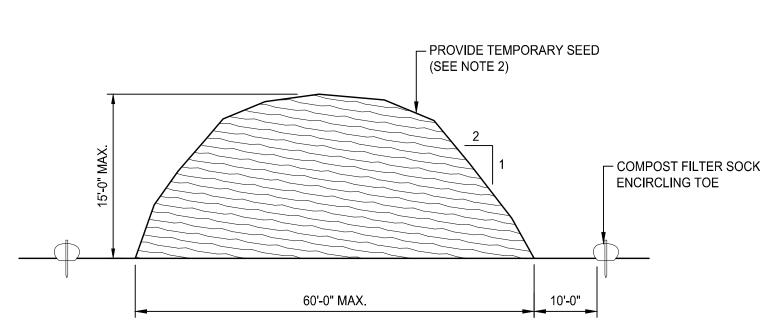

- 1. STOCKPILE AREA SHALL NOT EXCEED SPECIFIED DIMENSIONS WITHOUT APPROVAL FROM ENGINEER.
- 2. STOCKPILED ERODIBLE MATERIAL THAT WILL NOT BE USED FOR GREATER THAN 14 DAYS SHALL BE STABILIZED WITH TEMPORARY SEED IMMEDIATELY FOLLOWING PLACEMENT. USE RIDOT STD. M.18.10.5 SEED MIX.

ERODIBLE MATERIAL STOCKPILE



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PROJECT NAME

Newton, MA. 02460

Newton Center for Active Living 345 Walnut Street,

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CIVIL ENGINEER Pare Corporation 10 Lincoln Rd, Suite 210 Foxboro, MA 02035

Tel: 508.543.1755


CIVIL ENGINEER Kyle Zick Landscape Architecture, Inc. 136 Bromfield St, Suite 202 Boston, MA 02108 Tel: 617.451.1018


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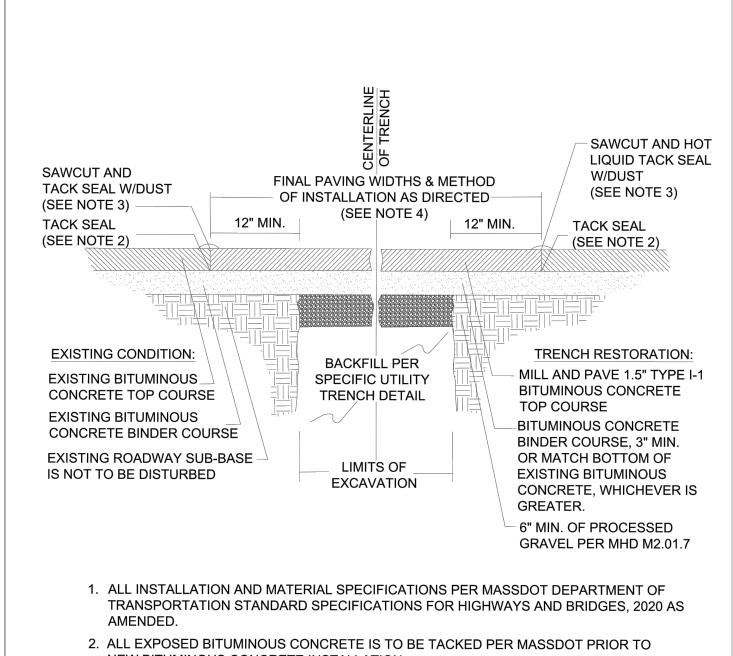
DETAILS 1



DRAWING NUMBER




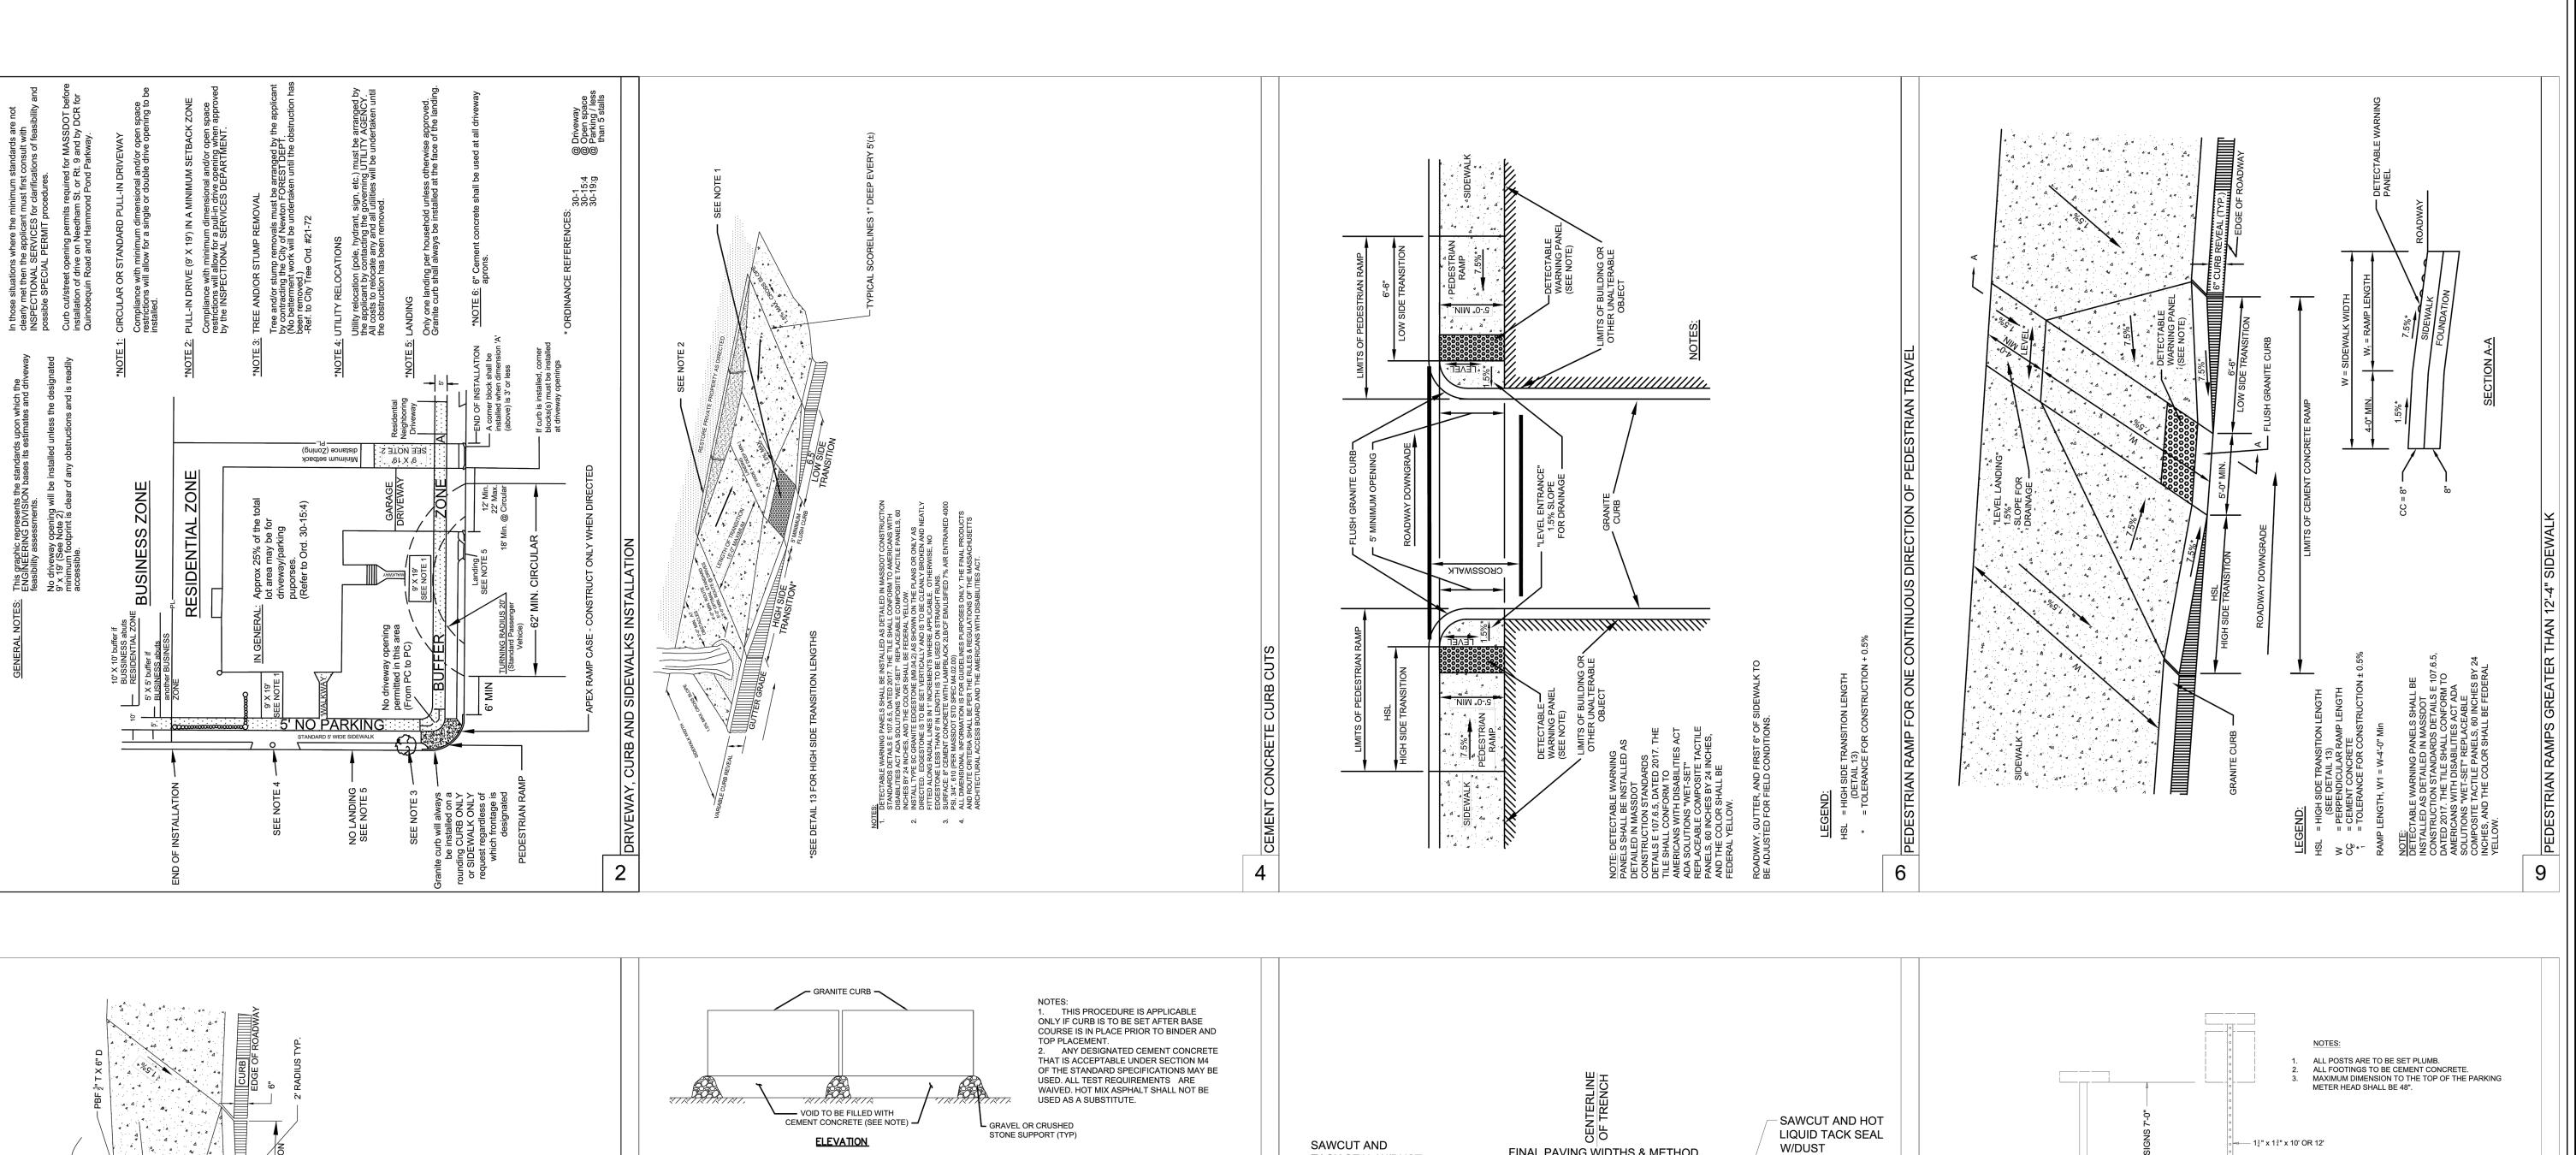

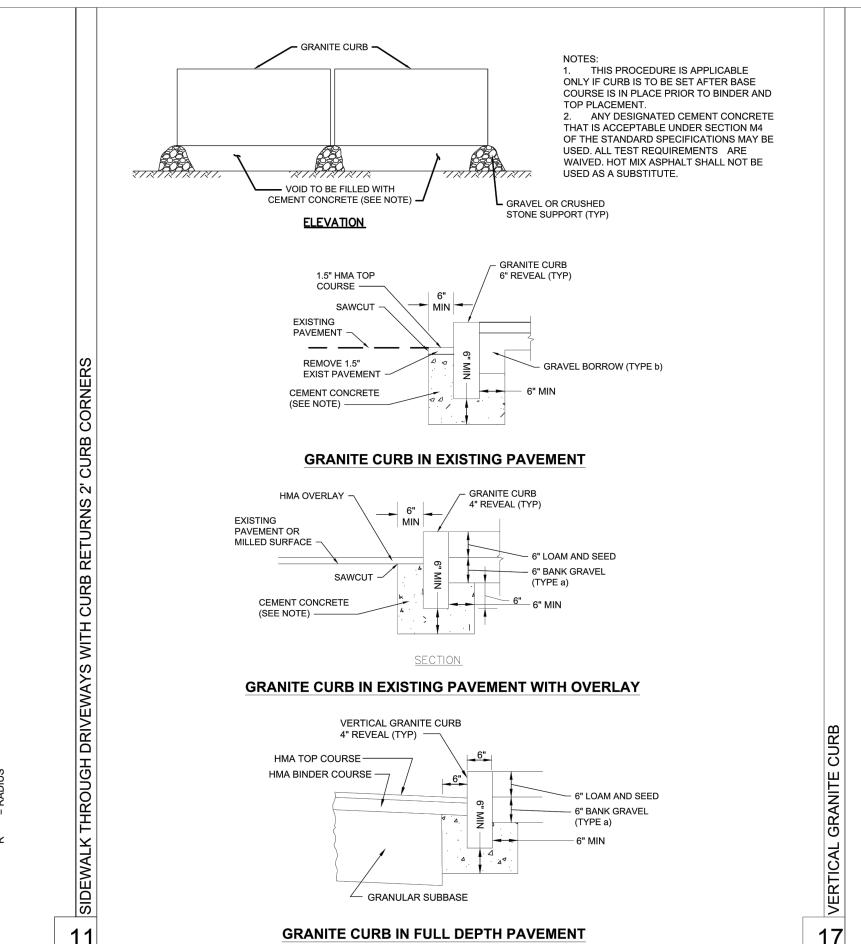

- NEW BITUMINOUS CONCRETE INSTALLATION. 3. ALL EXPOSED JOINTS ARE TO BE SEALED WITH TACK AND STONE DUST.
- 4. ANY TOP COURSE APPLIED AT A WIDTH OF 6' WIDE OR GREATER IS TO BE PLACED BY MACHINE/BOX SPREADER WHEN & AS DIRECTED BY THE CITY OF NEWTON.

SUPER PAVE FOR PAVEMENT

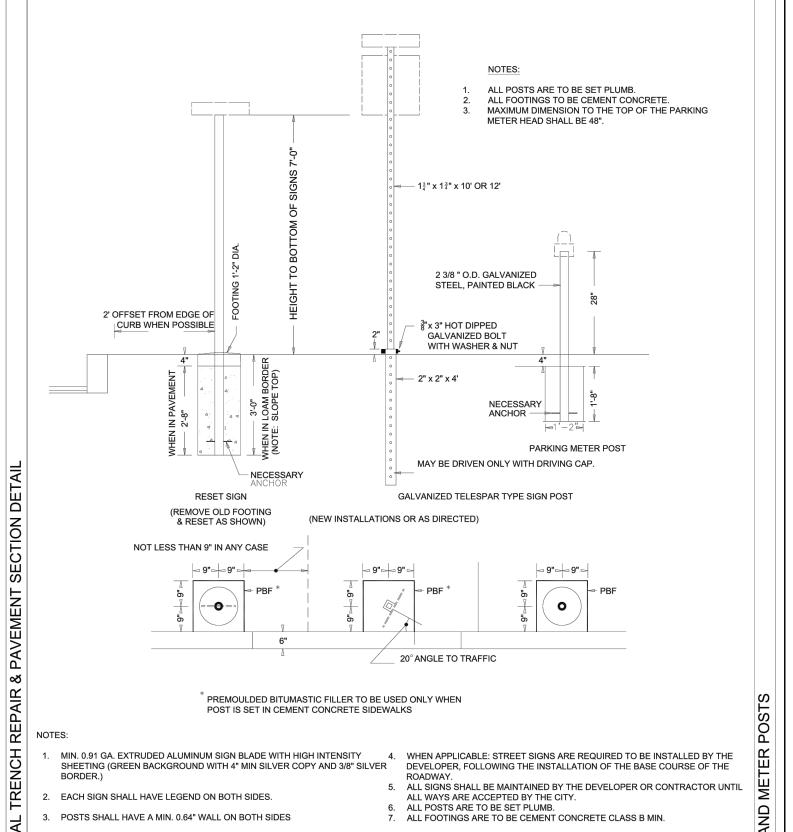

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PROJECT TEAM

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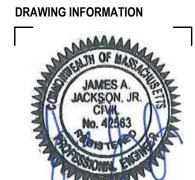
Tel: 617.451.1018

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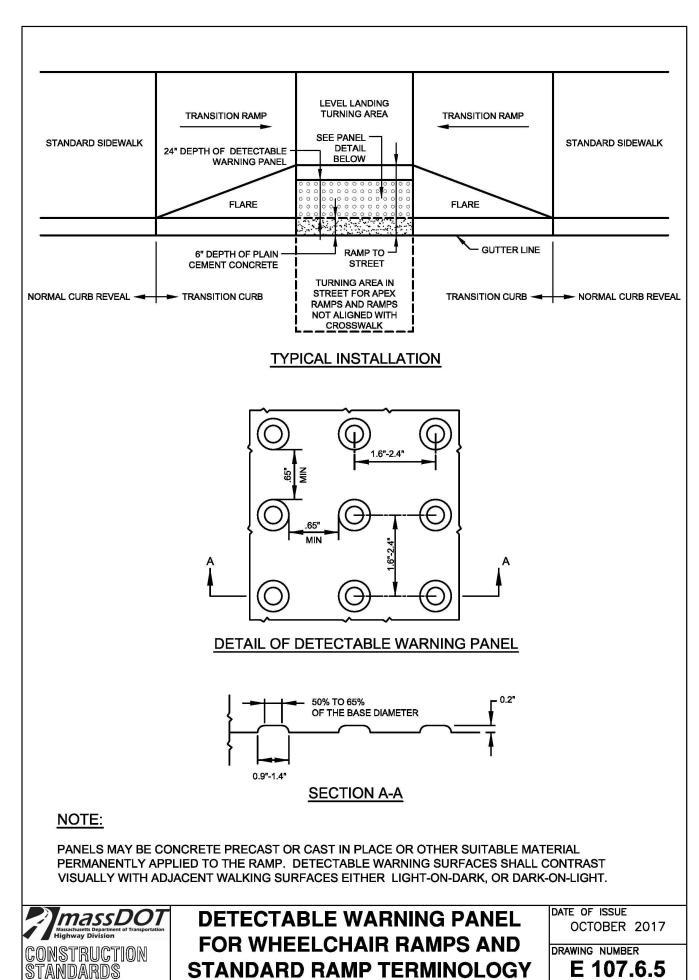
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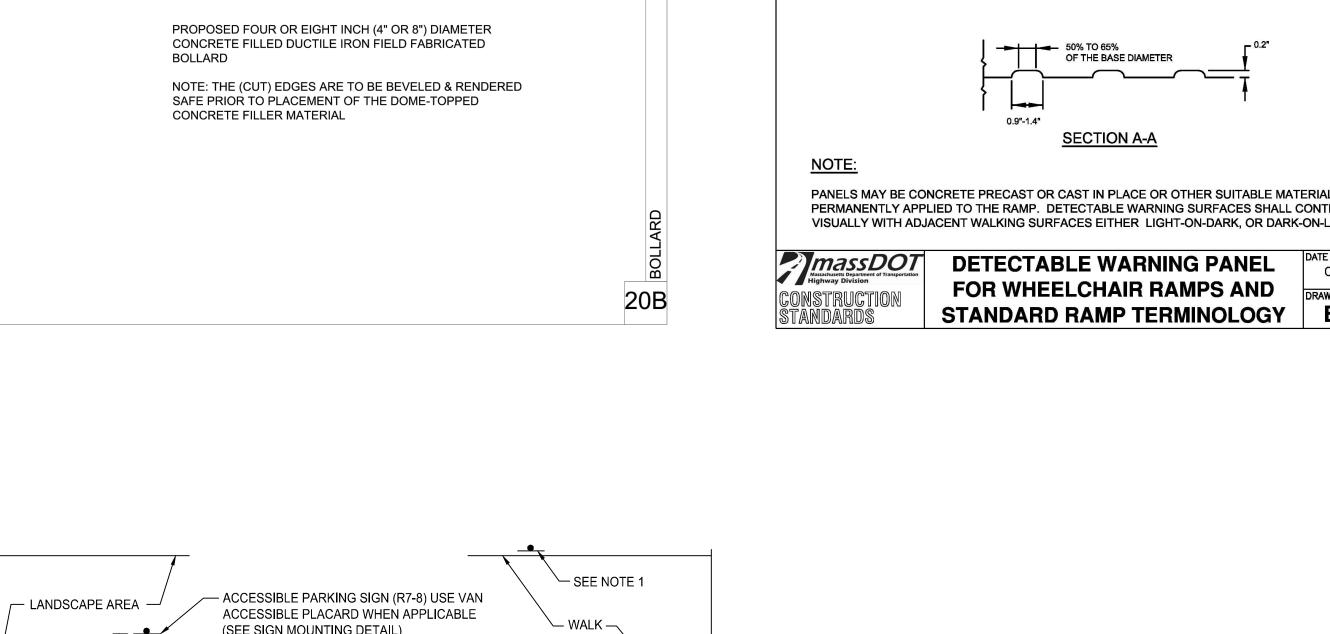
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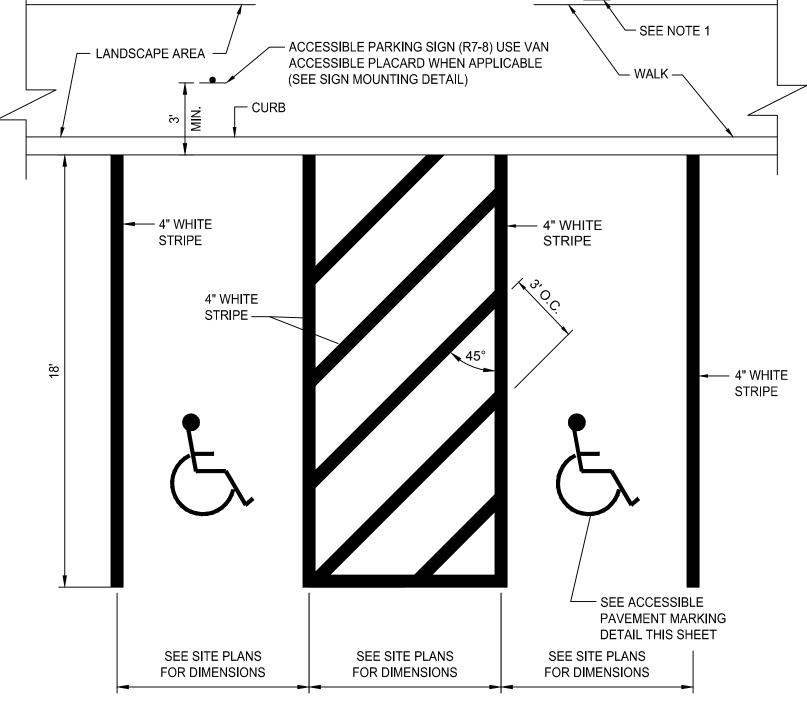
DETAILS 2



DRAWING NUMBER








WHERE STALLS ABUT SIDEWALK, PARKING SIGNS

SHOULD BE PLACED AT BACK EDGE OF SIDEWALK.


2. ALL PAVEMENT MARKINGS TO BE EPOXY RESIN.

ACCESSIBLE PARKING STALLS @ 90° NOT TO SCALE

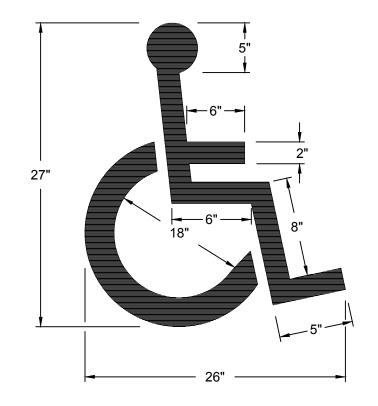

ACCESSIBLE PARKING AND SIGNAGE SHALL BE IN CONFORMANCE WITH THE RULES & REGULATIONS OF THE AMERICANS WITH DISABILITIES ACT.


> ACCESSIBLE PAVEMENT MARKING NOT TO SCALE

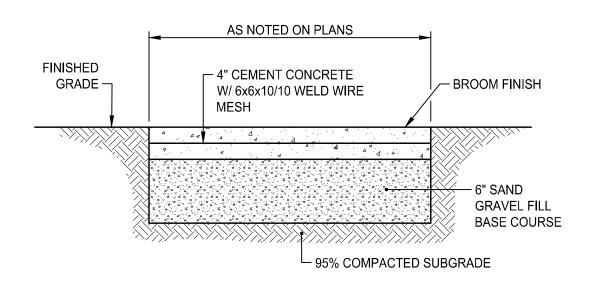

NOTES:


- 1. CONCRETE SIDEWALK SHALL BE CONSTRUCTED IN ACCORDANCE WITH SECTION 905 OF THE RI STANDARD SPECIFICATIONS.
- 2. WIRE MESH SHALL BE IN ACCORDANCE WITH SECTION M.05.02 OF THE RI STANDARD SPECIFICATIONS.

TYPICAL CEMENT CONCRETE SIDEWALK NOT TO SCALE

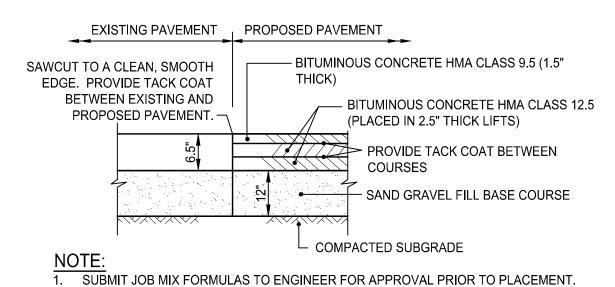

2. MINIMUM PAVEMENT COURSE THICKNESS SHALL BE MODIFIED TO MATCH EXISTING PAVEMENT THICKNESS SHOULD EXISTING PAVEMENT BE GREATER THAN THICKNESS SHOWN.


DRIVEWAY CUT AND MATCH DETAIL NOT TO SCALE

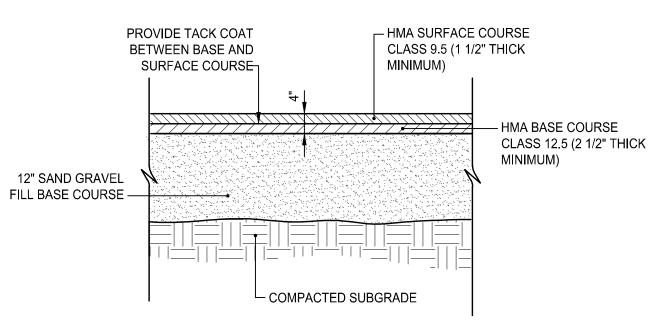


NOTE:


1. SUBMIT JOB MIX FORMULAS TO ENGINEER FOR APPROVAL PRIOR TO PLACEMENT.


HOT MIX ASPHALT PAVEMENT NOT TO SCALE

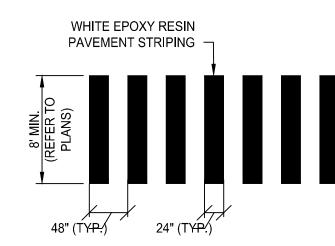

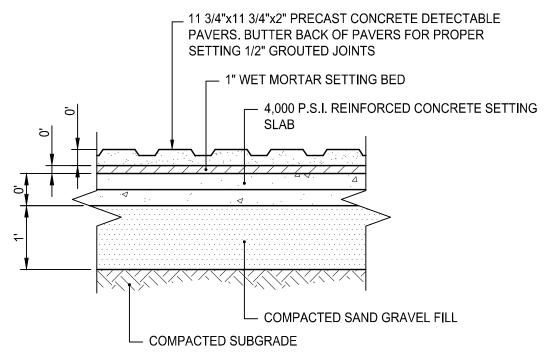

DETECTABLE WARNING PAVER NOT TO SCALE

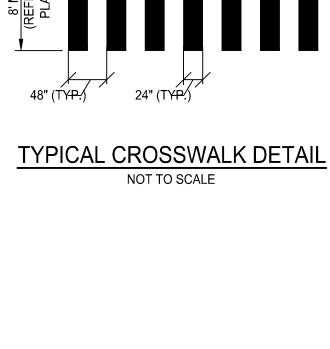

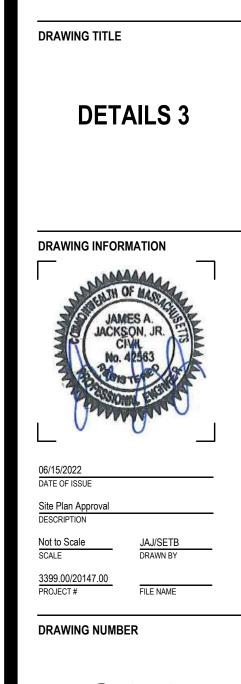

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Newton Center for

Boston, MA 02210 (617) 350 0450

PROJECT NAME

345 Walnut Street, Newton, MA. 02460

Active Living

City of Newton

PROJECT TEAM

CIVIL ENGINEER Pare Corporation

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Foxboro, MA 02035 Tel: 508.543.1755


CIVIL ENGINEER


Tel: 617.451.1018


REVISIONS

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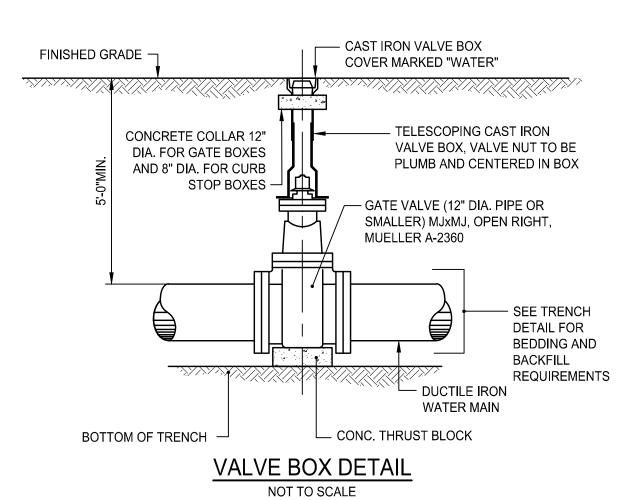
136 Bromfield St, Suite 202 Boston, MA 02108



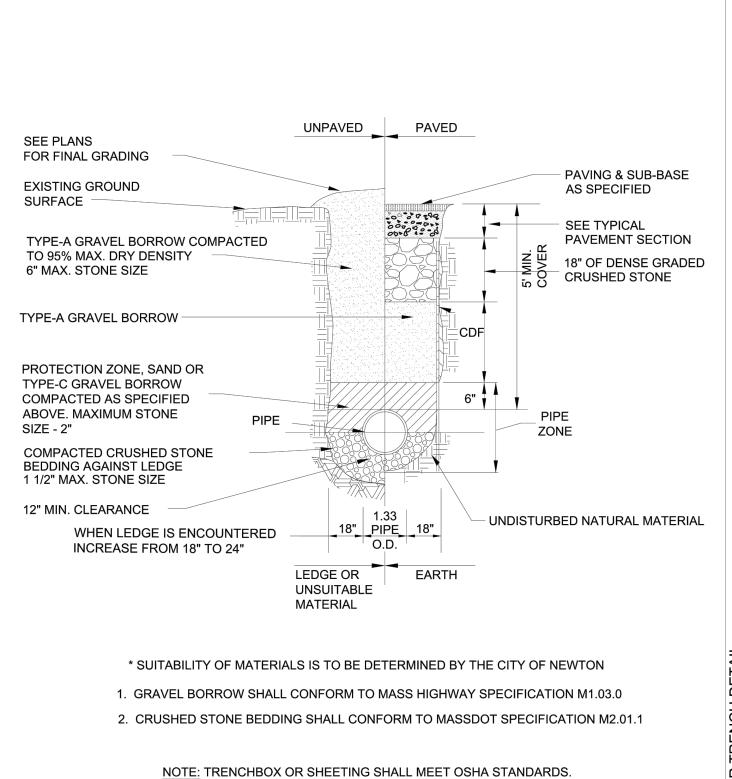

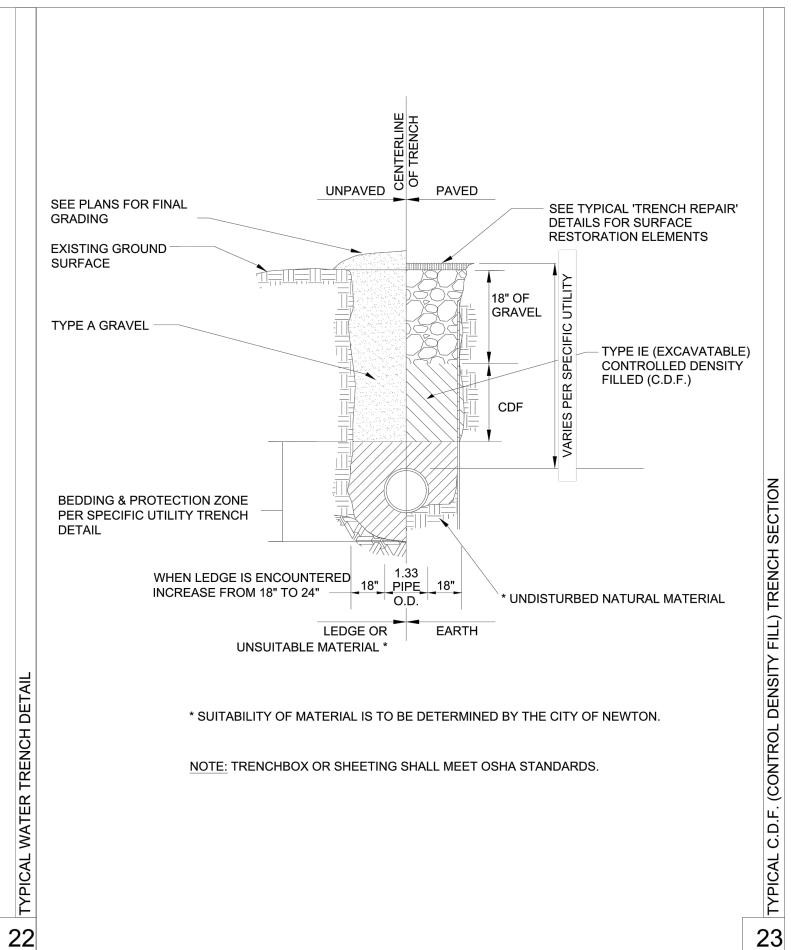

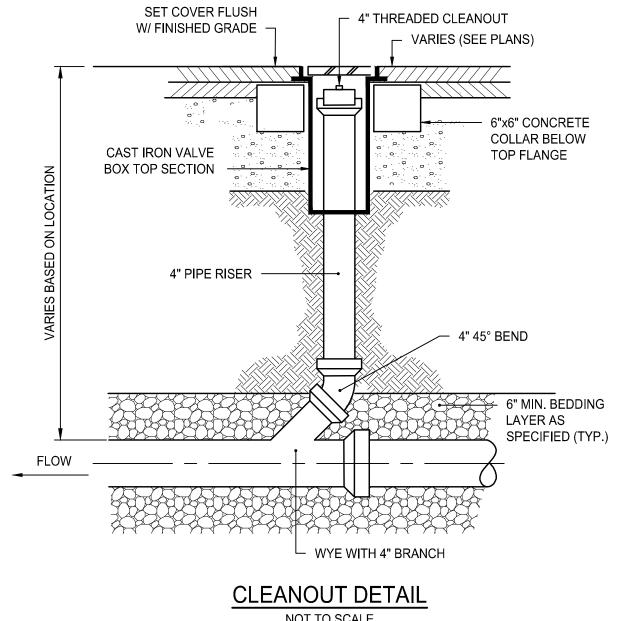
NOT TO SCALE



ADS STORMTECH MC-3500 CHAMBER OR APPROVED -— GRANULAR FILL COMPACTED IN 6" **EQUIVALENT** LIFTS TO MIN. 95% STANDARD PAVEMENT PROCTOR DENSITY. ROLLER GROSS 1-1/2" DOUBLE-WASHED, VEHICLE WEIGHT NOT TO EXCEED CRUSHED, ANGULAR STONE -12,000 LBS. DYNAMIC FORCES NOT TO END CAP -EXCEED 20,000 LBS. ELEV.(1)= 55.00 ELEV.(1)= 54.00 ELEV.(1)= 50.25 ELEV.(1)= 49.50 = ESTIMATED SEASONAL HIGH GROUNDWATER **TABLE** ELEV = 47.50' DETERMINED BY TEST NATURAL SANDY SOIL. SCARIFY PRIOR TO PITS CONDUCTED ON PLACEMENT OF SAND OR -5/25/2022 BY PARE FILTER FABRIC AND STONE CORPORATION SHOWING NO GW TO A DEPTH OF 120" BELOW NOTES: GRADE

- 1. CONTRACTOR SHALL TAKE PRECAUTION NOT TO COMPACT SUBGRADE.
- 2. CONTRACTOR SHALL NOT PLACE OR OPERATE MACHINERY ON SUBGRADE.
- 3. CONTRACTOR SHALL NOTIFY ENGINEER (48 HRS MIN) PRIOR TO EXPOSING SUBGRADE TO SCHEDULE INSPECTION.
- 4. ONCE CONTRACTOR HAS SUBGRADE EXPOSED, THE ENGINEER SHALL BE CONTACTED FOR INSPECTION.
- 5. CONSTRUCTION OF THE SYSTEM SHALL NOT COMMENCE UNTIL ENGINEER INSPECTS SUBGRADE AND CRUSHED
- 6. CONTRACTOR SHALL INSTALL UNDERGROUND INFILTRATION SYSTEM PER MANUFACTURERS RECOMMENDATIONS.

UNDERGROUND INFILTRATION SYSTEM DETAIL

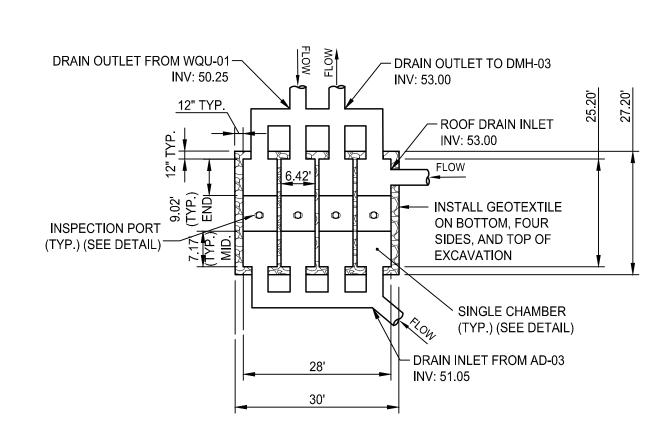

UNDERGROUND INFILTRATION SYSTEM (UGIS-1) PLAN VIEW NOT TO SCALE

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Newton Center for **Active Living** 345 Walnut Street, Newton, MA. 02460

PROJECT NAME

City of Newton

PROJECT TEAM

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Tel: 617.451.1018

CIVIL ENGINEER Kyle Zick Landscape Architecture, Inc. 136 Bromfield St, Suite 202 Boston, MA 02108

REVISIONS

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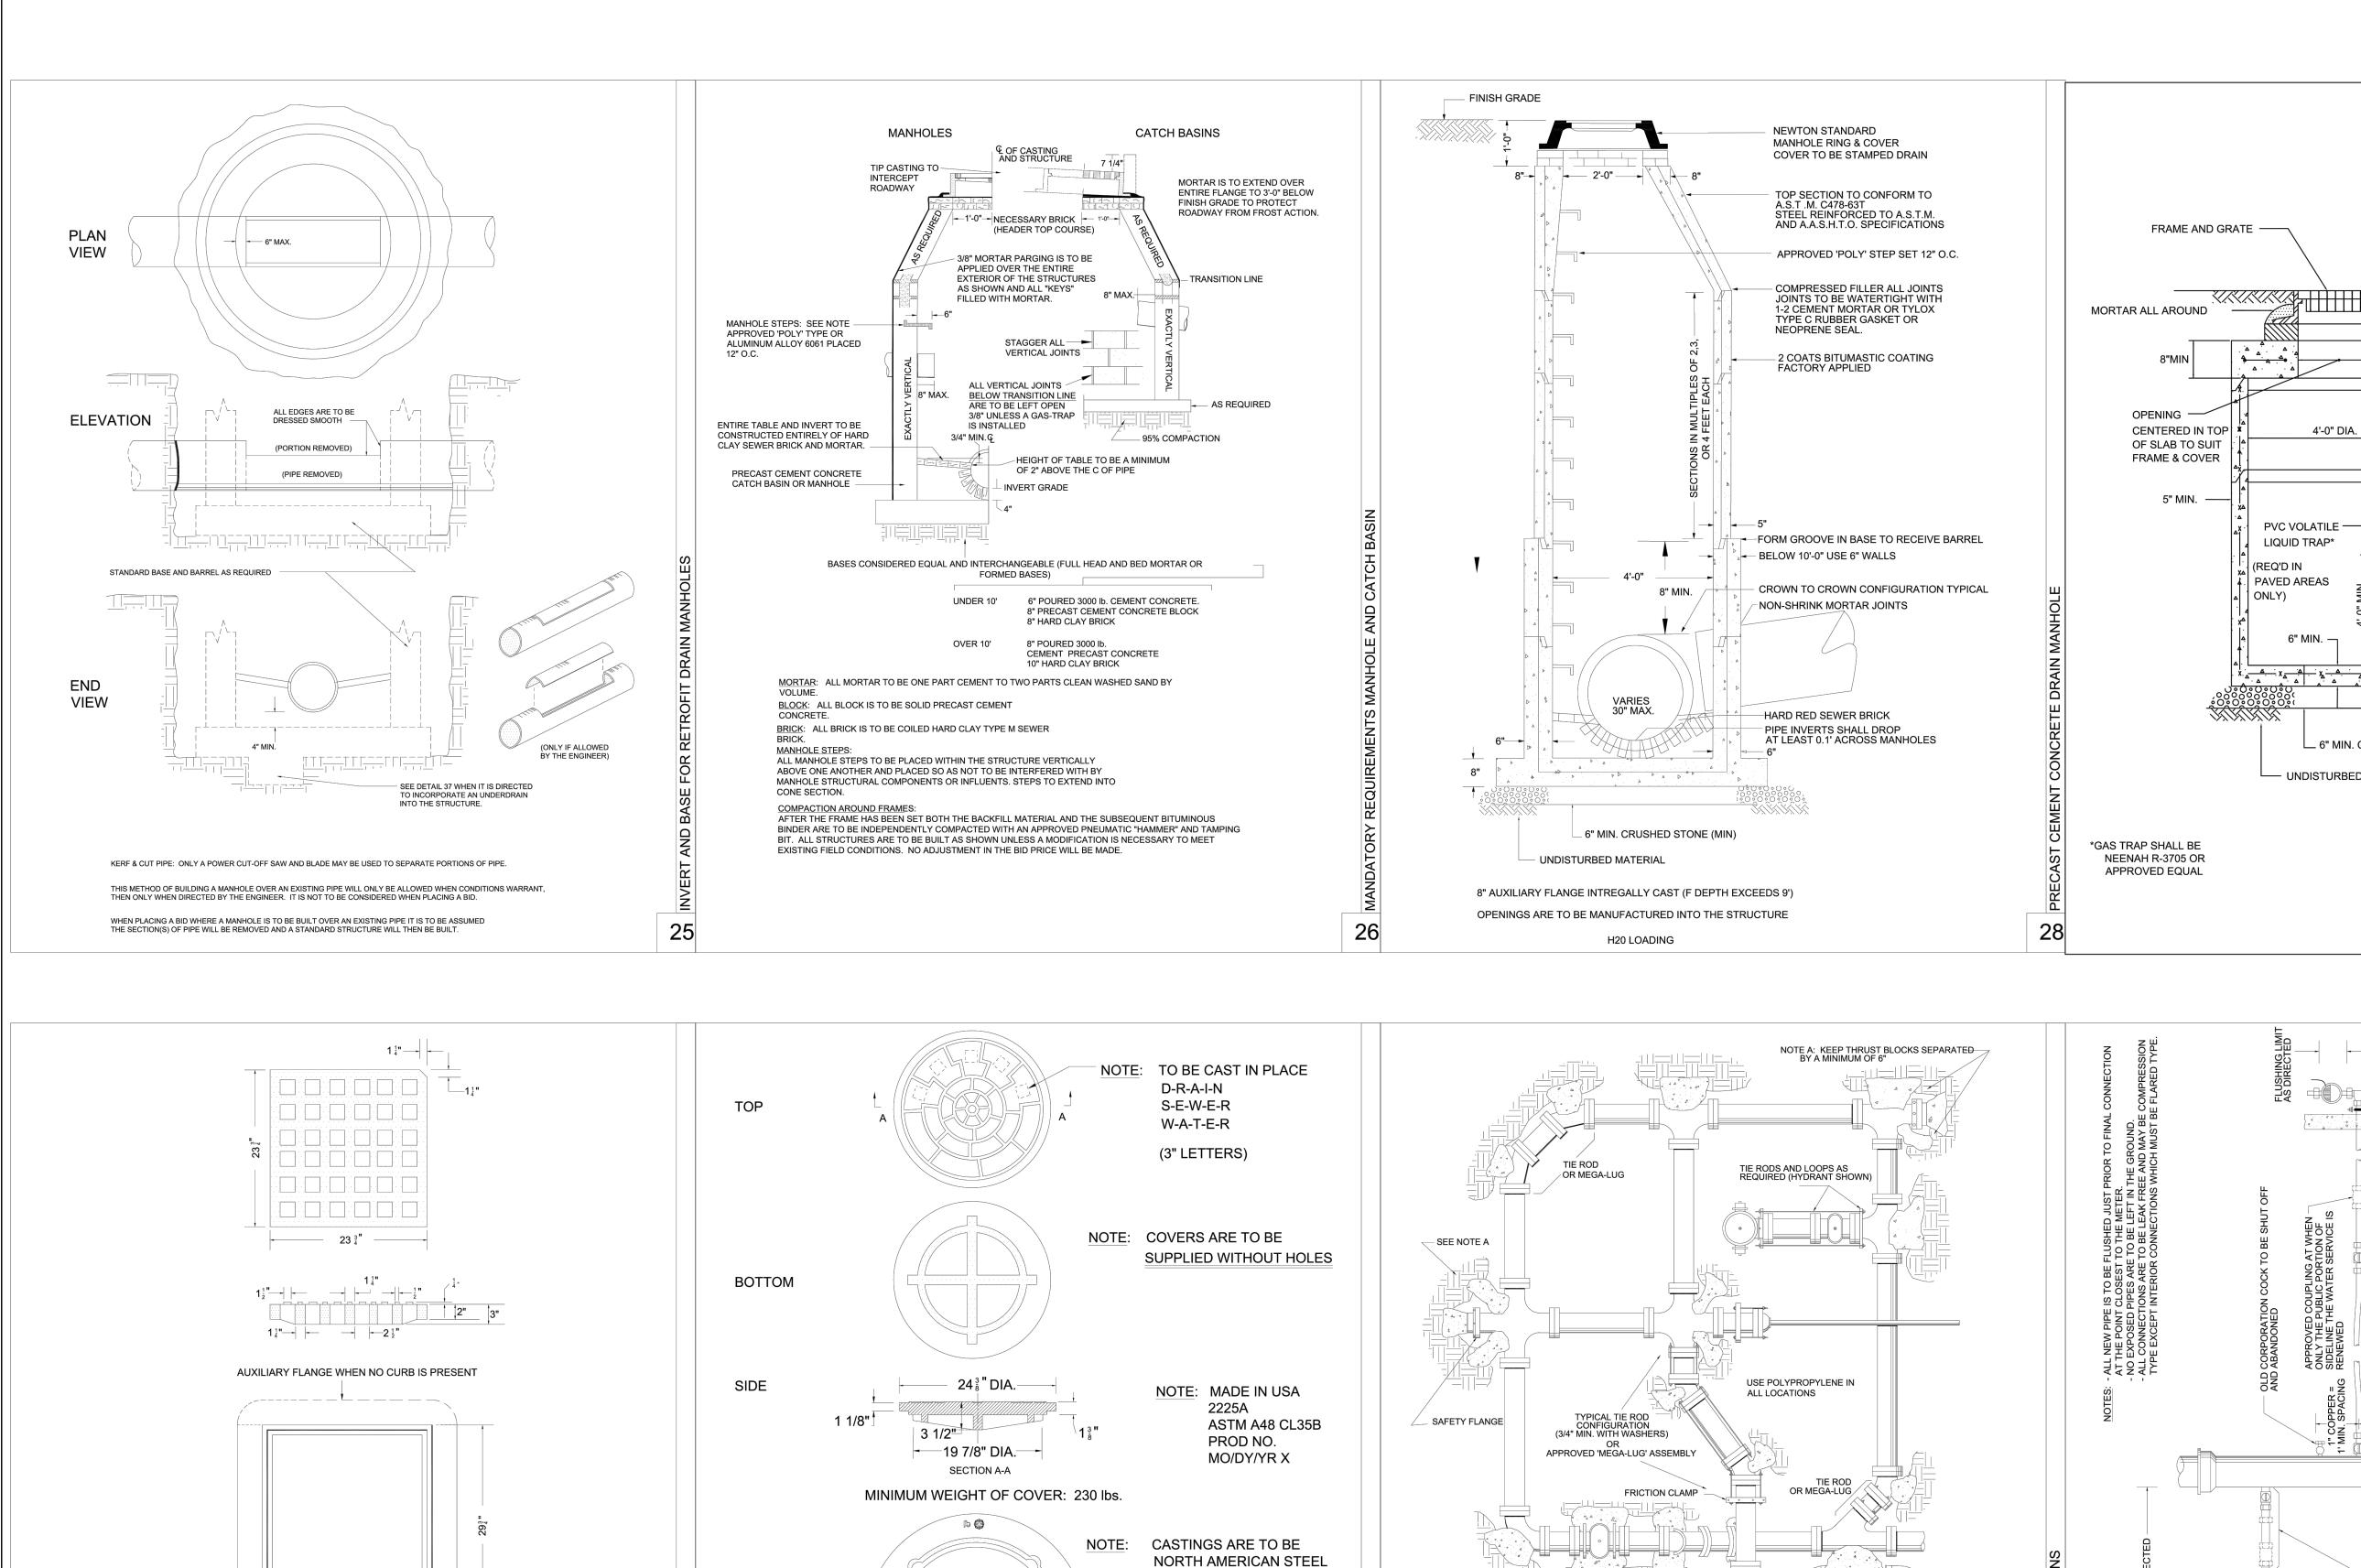
DETAILS 4

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STONE AND GRANTS PERMISSION TO PROCEED. NOT TO SCALE



ONLY

LOADING

MINIMUM WEIGHT OF FRAME: 250 lbs.

SHALL MEET OR EXCEED H20

THRUST BLOCKS ARE TO BE OF CLASS B CONCRETE OR OTHER APPROVED MEANS, OF SUFFICIENT SIZE AS APPROVED AND SHALL EXTEND TO UNDISTURBED SUITABLE MATERIAL

MATERIAL.
(NOTE: CONCRETE IS TO BE KEPT CLEAR
OF ALL NUTS, BOLTS, FLANGES, AND JOINTS)

WRAP-AROUND STEEL RESTRAINING LOOPS IN CONCRETE KEYED TO BANK. RESTRAINED GATE AND BEND SHOWN. USE AS DIRECTED.

FRICTION CLAMPS WITH CONCRETE ENVELOPE KEYED TO BANK

PER DESIGNER.

55

TIE ROD AND SAFETY FLANGE

ELEVATION VIEW

FRICTION CLAMP OR STIRRUP TYPE


TOP

SIDE

22 9/16" - |

— 26 1/4"-

SECTION A-A

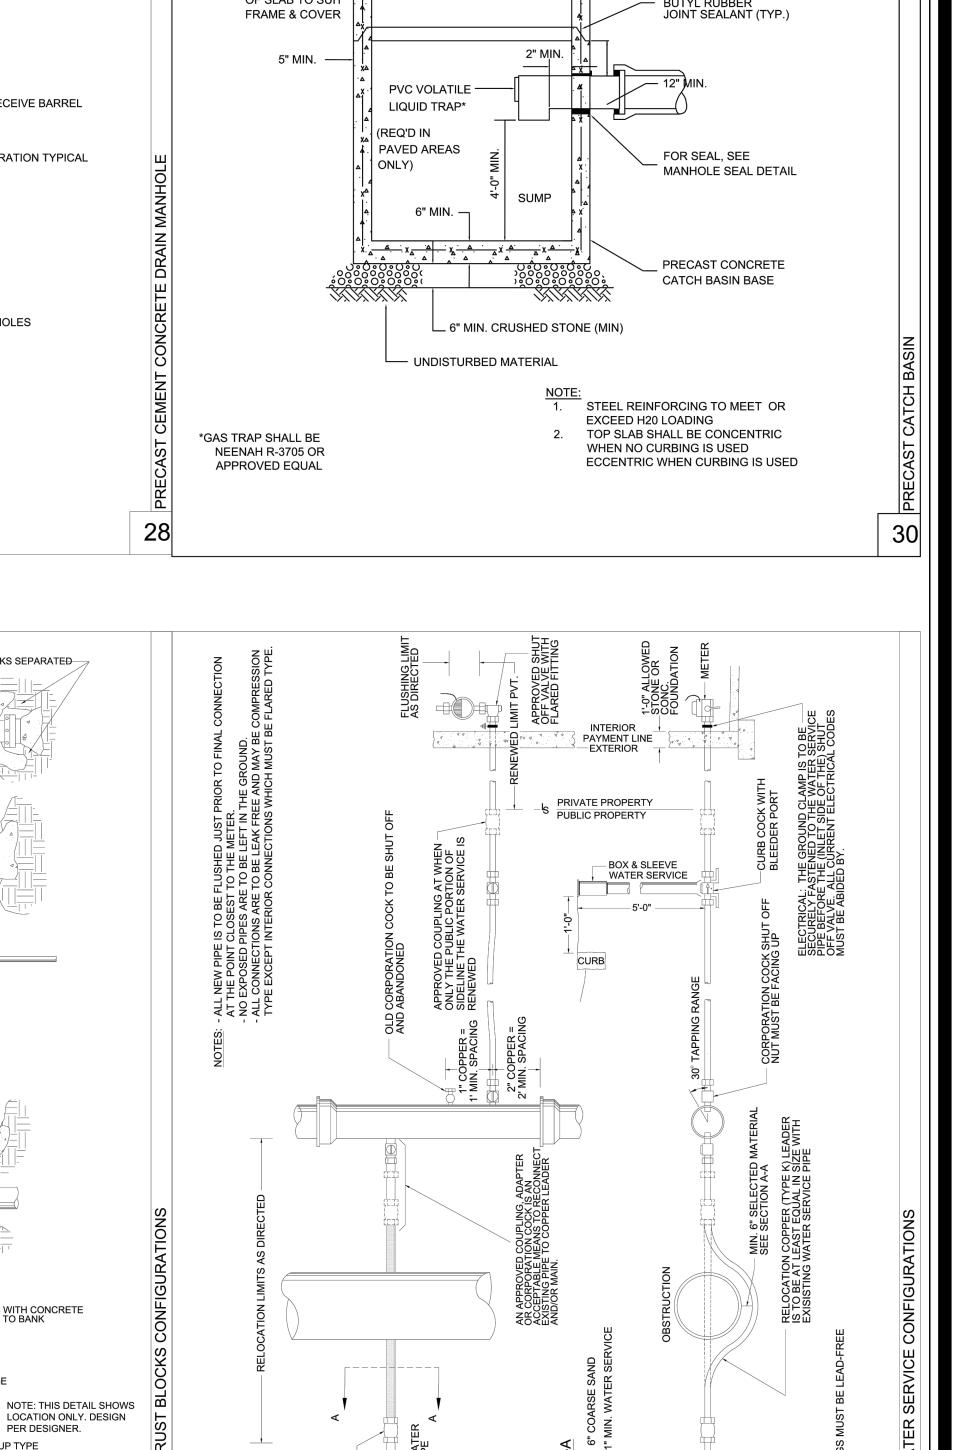

_ FINISHED GRADE

ADJUST TO REQUIRED GRADE

WITH BRICK MASONRY MIN. 1

COURSE, MAX. 3 COURSES OR

CONCRETE GRADING RINGS. ALL

BRICKS TO BE LAID AS HEADERS

PRECAST CONCRETE TOP SLAB

PRECAST CONCRETE

CATCH BASIN RISER

(SEE PLAN)

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DETAILS 5

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56


C6.5

1" --- 4½" ---

NOTES: MINIMUM WEIGHT OF GRATE AND FRAME - 480 lbs.

ALL FRAMES AND COVERS SHALL MEET OR EXCEED H20 LOADING

NORTH AMERICAN STEEL ONLY

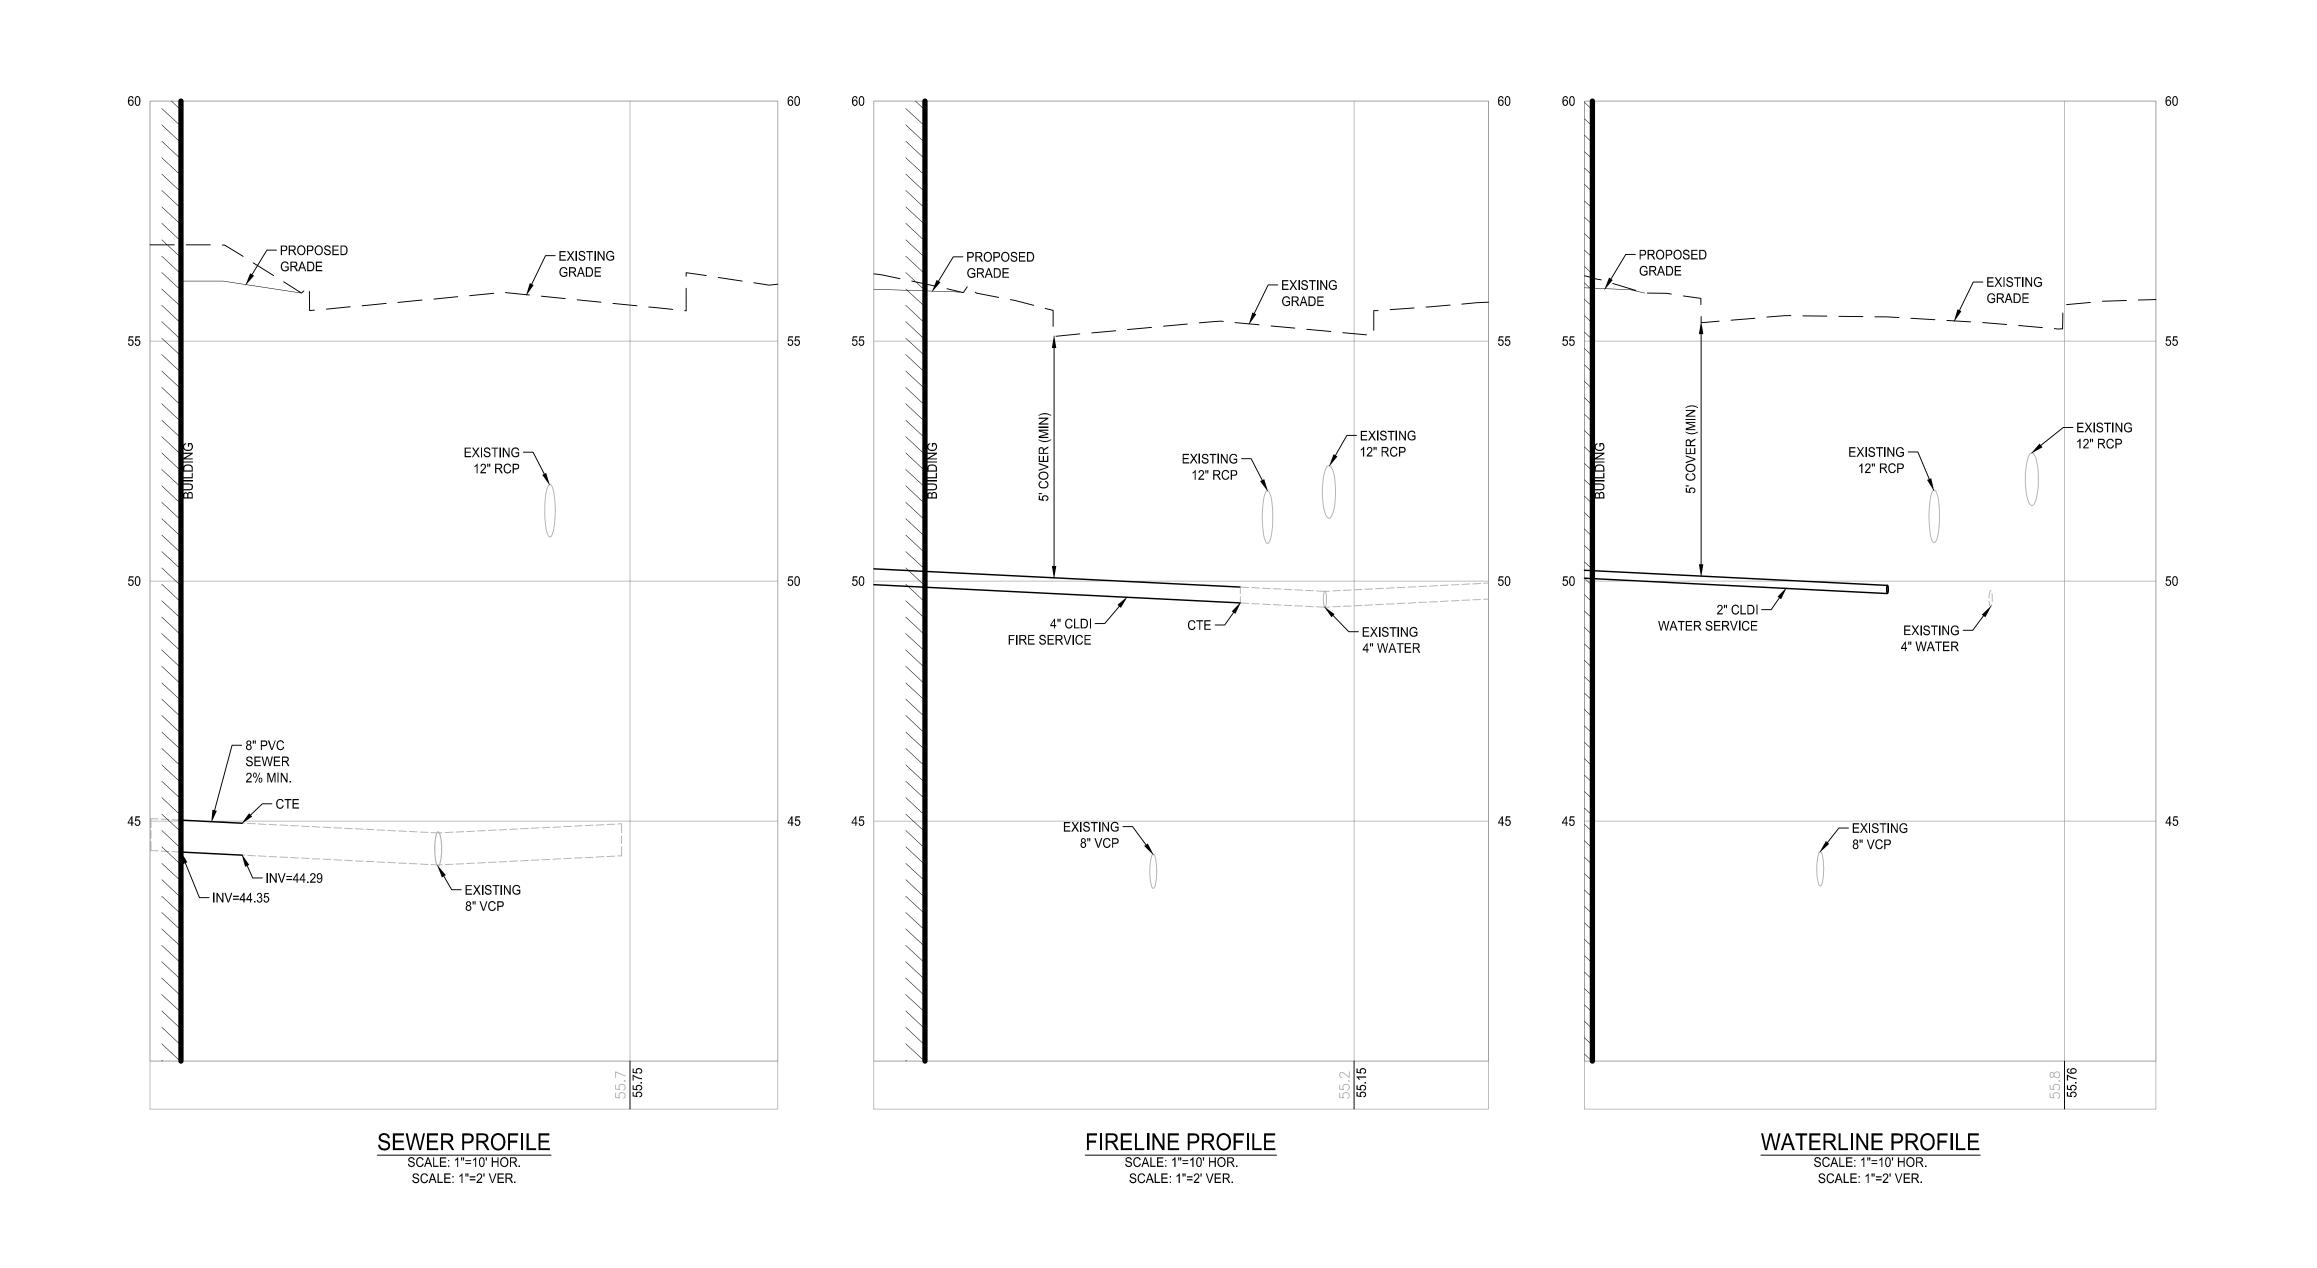

ARCHITECT **bha**

Bargmann Hendrie + Archetype, Inc. 9 Channel Center Street, Suite 300 Boston, MA 02210 (617) 350 0450

PROJECT NAME

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CIVIL ENGINEER

Kyle Zick Landscape Architecture, Inc.
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Boston, MA 02108

Tel: 617.451.1018

REVISIONS

DRAWING TITLE

PROFILES

DRAWING INFORMATION



06/15/2022
DATE OF ISSUE
Site Plan Approval

Site Plan Approval
DESCRIPTION

Not to Scale

CALE [

PROJECT#

DRAWING NUMBER

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architect has been a

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PROJECT NAME

Newton Center for

Active Living

City of Newton

345 Walnut Street, Newton, MA. 02460

PROJECT TEAM

CIVIL ENGINEER
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10 Lincoln Rd, Suite 210
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Tel: 617.451.1018

Landscape Architect

Kyle Zick Landscape Architecture, Inc.
136 Bromfield St, Suite 202

Boston, MA 02108

REVISIONS

DATE

DRAWING TITLE

Second Floor Plan

DRAWING INFORMATION

June 28, 2022

DATE OF ISSUE

Site Plan Approval

DESCRIPTION

| DESCRIPTION | 1/8" = 1'-0" | CW | | DRAWN BY |

DRAWING NUMBER

Second Floor Plan

1/8" = 1'-0"

A102

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PROJECT NAME

Newton Center for

Active Living

345 Walnut Street, Newton, MA. 02460

City of Newton

PROJECT TEAM

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DATE

Third Floor Plan

DRAWING TITLE

DRAWING INFORMATION

June 28, 2022 DATE OF ISSUE

June 28, 2022

DATE OF ISSUE

Site Plan Approval

DESCRIPTION

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A103

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PROJECT NAME

Newton Center for Active Living
345 Walnut Street,
Newton, MA. 02460

City of Newton

PROJECT TEAM

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Roof Plan

DRAWING INFORMATION

DRAWING NUMBER

A104

bhla

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PROJECT NAME

Newton Center for Active Living 345 Walnut Street, Newton, MA. 02460

CLIENT

City of Newton

PROJECT TEAM

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Tel: 508.543.1755

Landscape Architect
Kyle Zick Landscape Architecture, Inc.
136 Bromfield St, Suite 202
Boston, MA 02108
Tel: 617.451.1018

REVISIONS

DRAWING TITLE

East and North Elevations

DRAWING INFORMATION

June 28, 2022

June 28, 2022
DATE OF ISSUE
Site Plan Approval
DESCRIPTION

| DESCRIPTION | 1/8" = 1'-0" | CW | | DRAWN BY | | 3399.00 | | PROJECT# | FILE NAME | |

DRAWING NUMBER

A200

bh a

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PROJECT NAME

Newton Center for Active Living 345 Walnut Street, Newton, MA. 02460

CLIENT

City of Newton

PROJECT TEAM

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Pare Corporation
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REVISIONS

DRAWING TITLE

South and West Elevations

DRAWING INFORMATION

June 28, 2022 DATE OF ISSUE

1/8" = 1'-0" Author

SCALE DRAWN BY

3399.00

PROJECT# FILE NAME

DRAWING NUMBER

A201



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PROJECT NAME

Newton Center for

Active Living

345 Walnut Street, Newton, MA. 02460

City of Newton

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REVISIONS

Building Sections

DRAWING INFORMATION

June 28, 2022

DATE OF ISSUE

Site Plan Approval

Site Plan Approval

DESCRIPTION

1/8" = 1'-0"

SCALE

CW

DRAWN BY

DRAWING NUMBER

A300